P23012 Wingates Plot 3

Drawing Register: EBM

Please note: All drawings listed below are hyperlinked to the drawings listed. Please click on the drawing title to go directly to the drawing of your choice.

Works Completed: Electrical

Works

Drawing No.	Drawing Title	Rev
P23012-EBM-03-XX-DR-E-0130	Unit 3 Main Office Lighting Layout	AF
P23012-EBM-03-XX-DR-E-0230	Unit 3 Main Office Fire Alarm Layout	AF
P23012-EBM-03-XX-DR-E-0330	Unit 3 Main Office Containment Layout	AF
P23012-EBM-03-XX-DR-E-0430	Unit 3 Main Office Containment Layout	AF
P23012-EBM-03-XX-DR-E-0530	Unit 3 Warehouse Electrical Services Layout	AF
P23012-EBM-03-ZZ-DR-E-000830	LV Schematic	AF
P23012-EBM-EX-XX-DR-E-0930	Unit 3 External Services Layout	AF
P23012-EBM-EX-XX-DR-E-0931	Unit 3 External Lighting & Lux Plot Layout	AF
P23012-EBM-EX-XX-DR-E-0933	Unit 3 External Lighting Elevation	AF
P23012-EBM-EX-XX-DR-E-0934	Unit 3 Structural Lightning Protection Layout	AF
P23012-EBM-EX-XX-DR-E-0935	Unit 3 Combined M&E External Services Layout	AF



Symbol	Article No	Name
A	!MODE L40	MOD EDGE UGR 36.3w, 3913lm, 4000k - 107Llm/CW
AE	!MODE L40 LS3	MOD EDGE UGR 36.3w 3 HR EMERGENCY, 3913lm, 4000k - 107Llm/CW
AD	!MODE L40 A	MOD EDGE UGR 36.3w DALI, 3913lm, 4000k - 107Llm/CW
DE	!MODE L40 A LS3	MOD EDGE UGR 36.3w DALI 3 HR EMERGENCY, 3913lm, 4000k - 107Llm/CW
B1	!BTECM L22	BTEC MEDIUM 14.6w, 1885LM, 4000K - 129LIM/CW
B1E	!BTECM L22 LS3	BTEC MEDIUM 14.6w 3 HR EMERGENCY, 1885LM, 4000K - 129LIM/CW
B2	!BTECL L40	BTEC LARGE 27w, 3428LM, 4000K - 127LIM/CW
B2E	!BTECL L40 LS3	BTEC LARGE 27w 3 HR EMERGENCY, 3428LM, 4000K - 127LIM/CW
B3	!BTECM65 L22	BTEC MEDIUM IP65, 14.6w, 1885LM, 4000K - 129LIM/CW
ВЗЕ	!BTECM65 L22 LS3	BTEC MEDIUM IP65, 14.6w, 3 HR EMERGENCY, 1885LM, 4000K - 129LIM/CW
B4	PTECDHO L40 60+PTECD SSR GY	PROTEC HIGH OUTPUT SEMI-SPECULAR REFLECTOR GREY BEZEL 60° LENS, 24.7w, 4000LM, 4000K
B4E	!PTECDHO L40 60 LS3+PTECD SSR GY	PROTEC HIGH OUTPUT SEMI-SPECULAR REFLECTOR GREY BEZEL 60° LENS 3 HR EMERGENCY, 24.7w, 4000LM, 4000K
En E1	!EXI3 M3 LS3	EMERGENCY EXIT SIGN (RUNNING MAN) MAINTAINED SELF TEST 3 HR EMERGENCY 3.6w
EMBH	EXIT-AME2 NM3 LS3	AME2 EMERGENCY BULKHEAD NON MAINTAINED SELF TEST 3 HR EMERGENCY 2.5w
F1 [*]	!F1-PTECF7 COB 60	PROTEC FIRE RATED DOWNLIGHT 60° REFLECTOR, 7.5w, 4000K - 96Llm/CW
F2 ^e	!PTECG6 COB 60 FR BC C83	PROTEC FR GIMBAL FIRE RATED DOWNLIGHT 60° REFLECTOR, 6.7w, 3000K - 73.43LIm/CW
GE	!GE-AMED L40 R25 LS3 & AWR	AMENITY DECORATIVE 26.8w, INTEGRAL SENSOR SELF TEST 3 HR EMERGENCY, 3271lm, 4000K - 122Llm/CW
G1E	!EPK L80 R44 LS3	ECOPAK SENSOR 1500mm 43.8w SELF TEST 3 HR EMERGENCY C/W INTEGRAL SENSOR, 7008lm, 4000K - 160Llm/CW
HE	!TYP L63 PC 5S LS3	

	LEGEND OF LIGHTING CONTROL SYMBOLS
SYMBOL	DESCRIPTION
P1 ●	SWITCHING PIR DETECTOR RECESSED
P2 ●	DIMMING PIR / PHOTOCELL DETECTOR RECESSED
P3 ●	MICROWAVE DETECTOR RECESSED
•	MANUAL SWITCH OR - OVERRIDE D - DIMMER
LCM	LIGHTING CONTROL MODULE
D	DIMMING MODULE
S	SWITCHING MODULE
X	X DENOTES NUMBER OF WAYS
_	SWITCHING

AF	AS FITTED.	LH	21/05/2024
Rev.	Description	Ву	Date
	SFITT		D
	ELECTRICALSERVI LIMITED	ICES	

<u>L</u>	EGEND OF SMALL POWER & DATA SYMBOLS
SYMBOL	DESCRIPTION
<u> </u>	SWITCHED FUSED CONNECTION UNIT
	DISTRIBUTION BOARD

<u>ACRONYMS</u> HIGH LEVEL CEILING VOID SOLENOID VALVE

DO NOT SCALE FROM THE DRAWING.
 EMERGENCY LIGHTING KEYSWITCHES ARE TO BE
 MOUNTED ADJACENT THE SERVING DISTRIBUTION

BOARD.


3. ILLUMINATED EMERGENCY EXIT SIGNAGE AND BULKHEAD LUMINARIES ARE TO BE NON-MAINTAINED


Title	UNIT 3 MAIN OFFICE
	LIGHTING LAYOUT


Project UNIT 3 WINGATES,


BOLTON

Scale	1:100	Drg. Size	A1	Date	18.10.2023
Drawn	LH	Checked	TW	Approved	XX
Drg. No.					Rev.
P2	3012-EE	3M-03-X	X-DR-E-(0130	AF

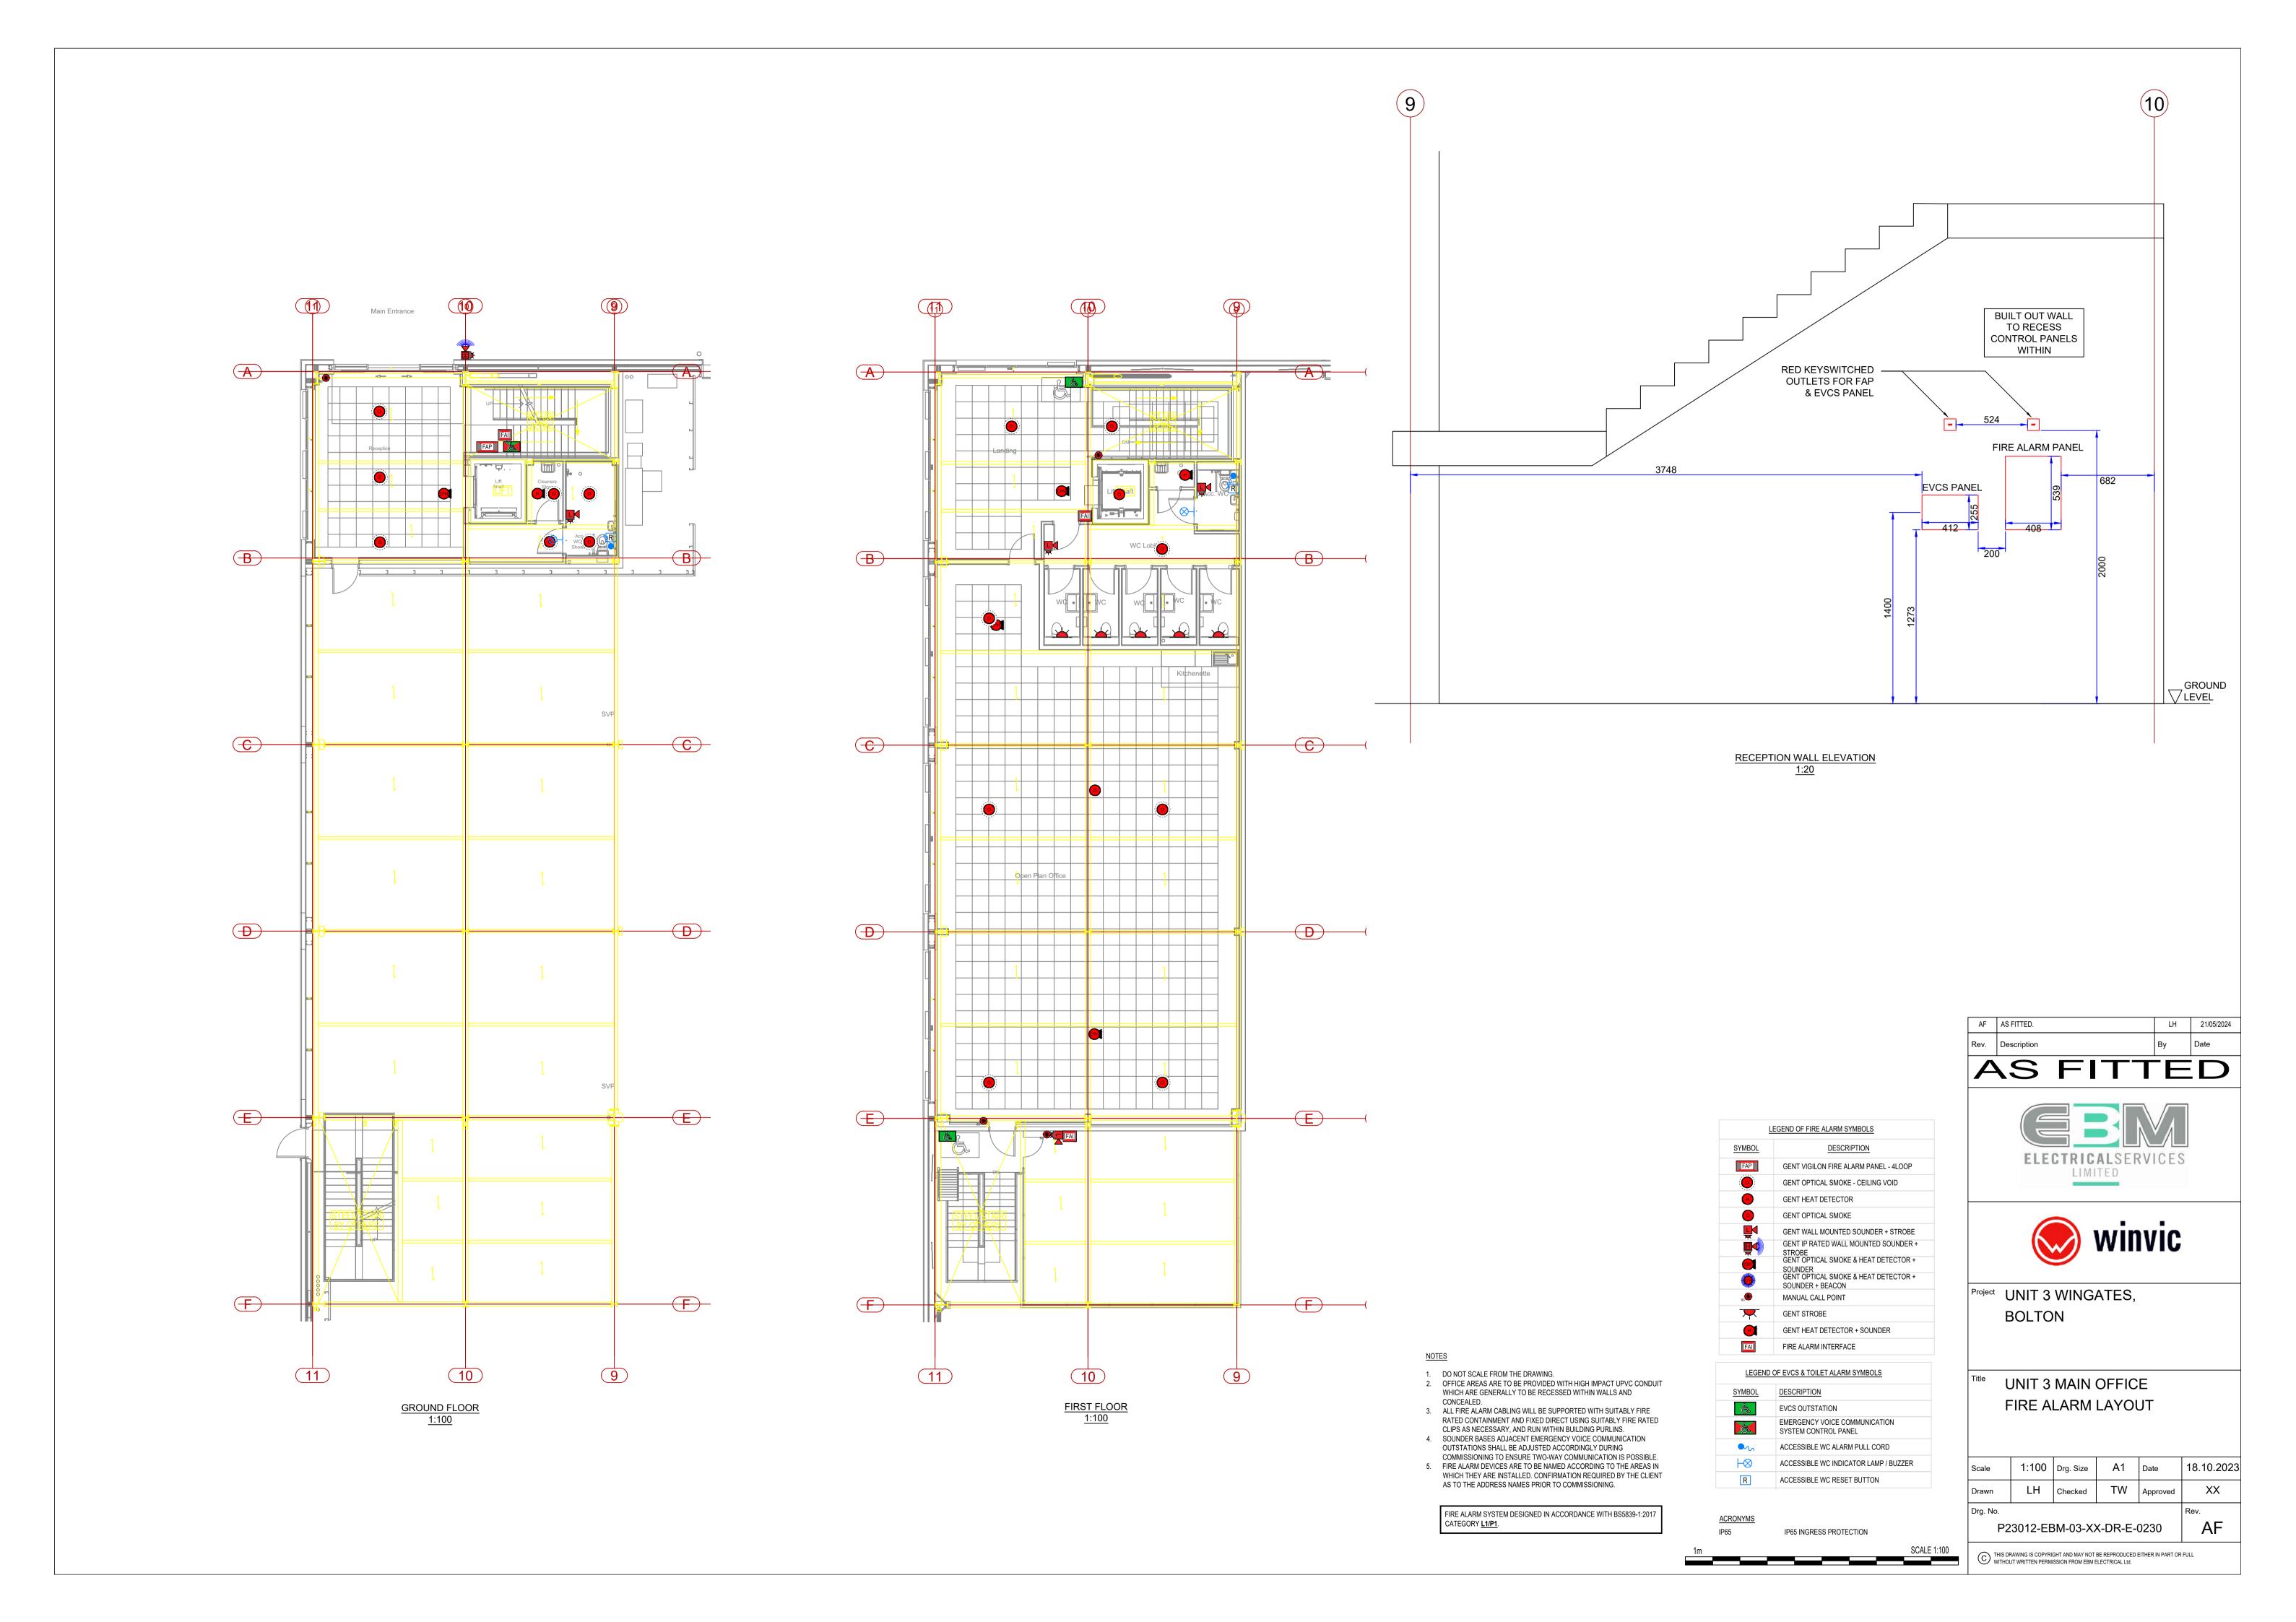

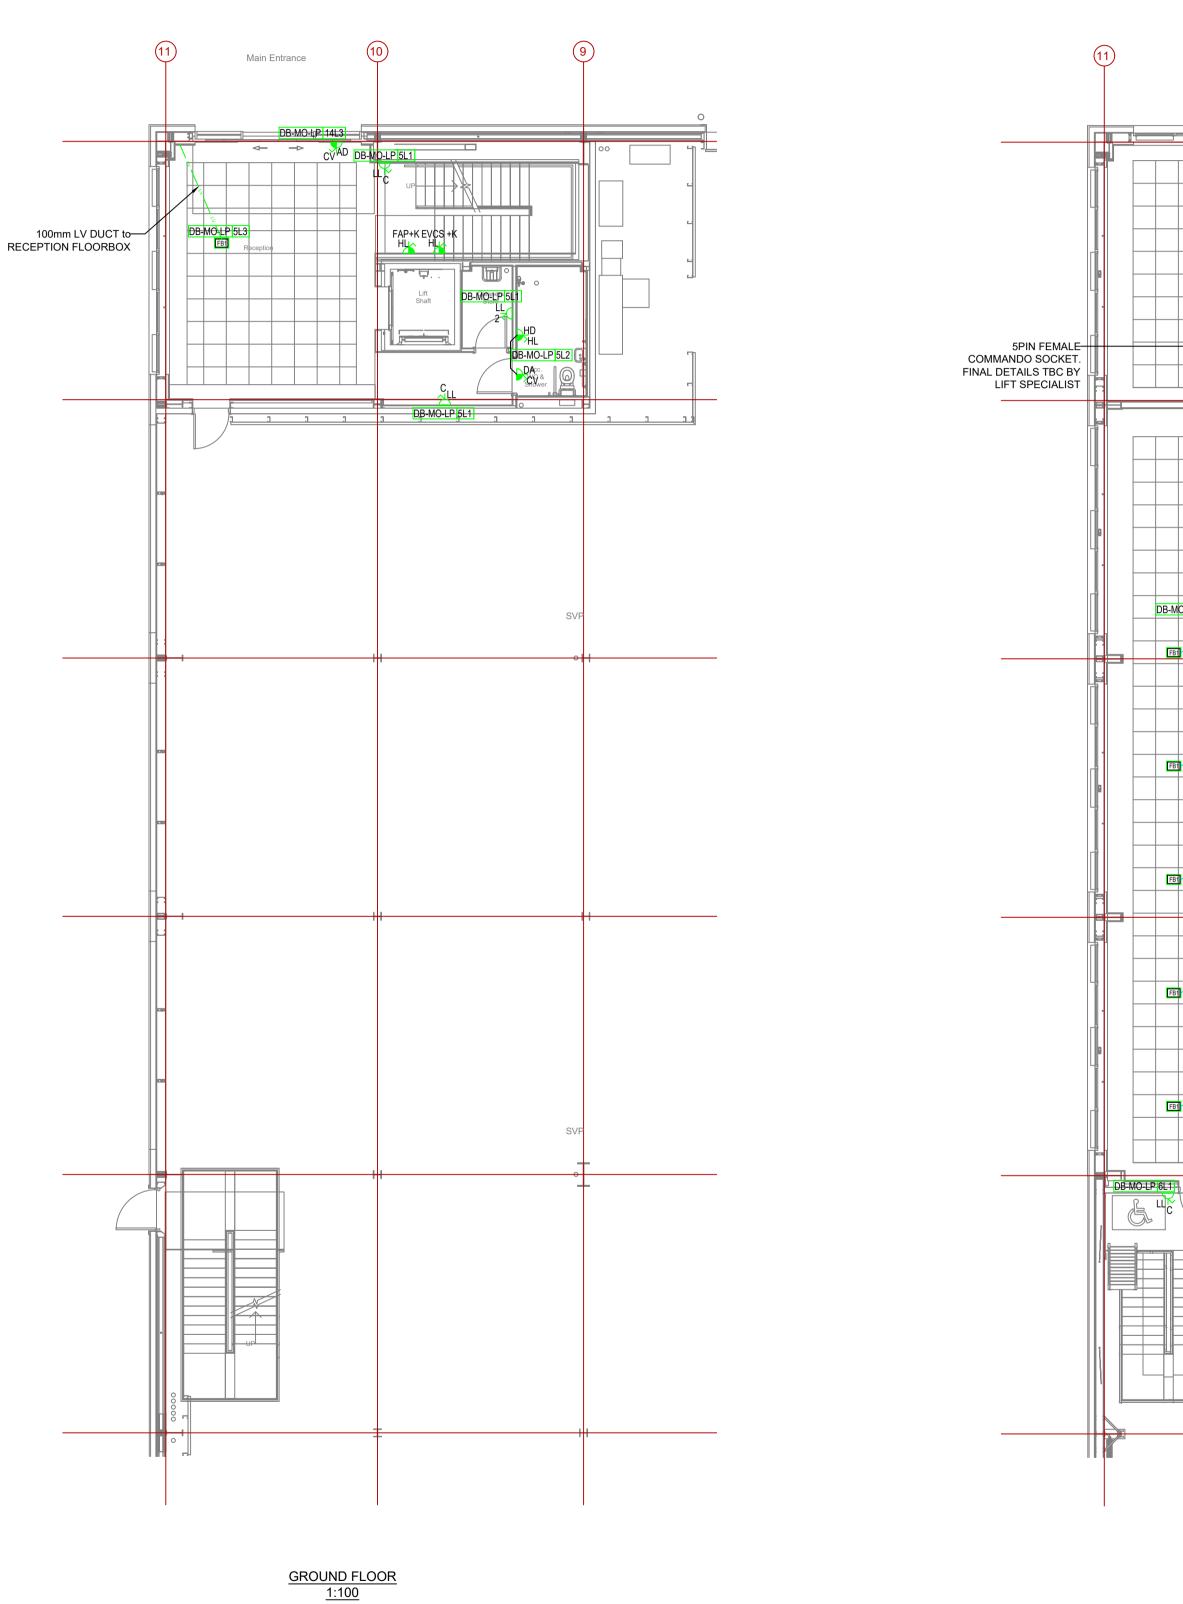

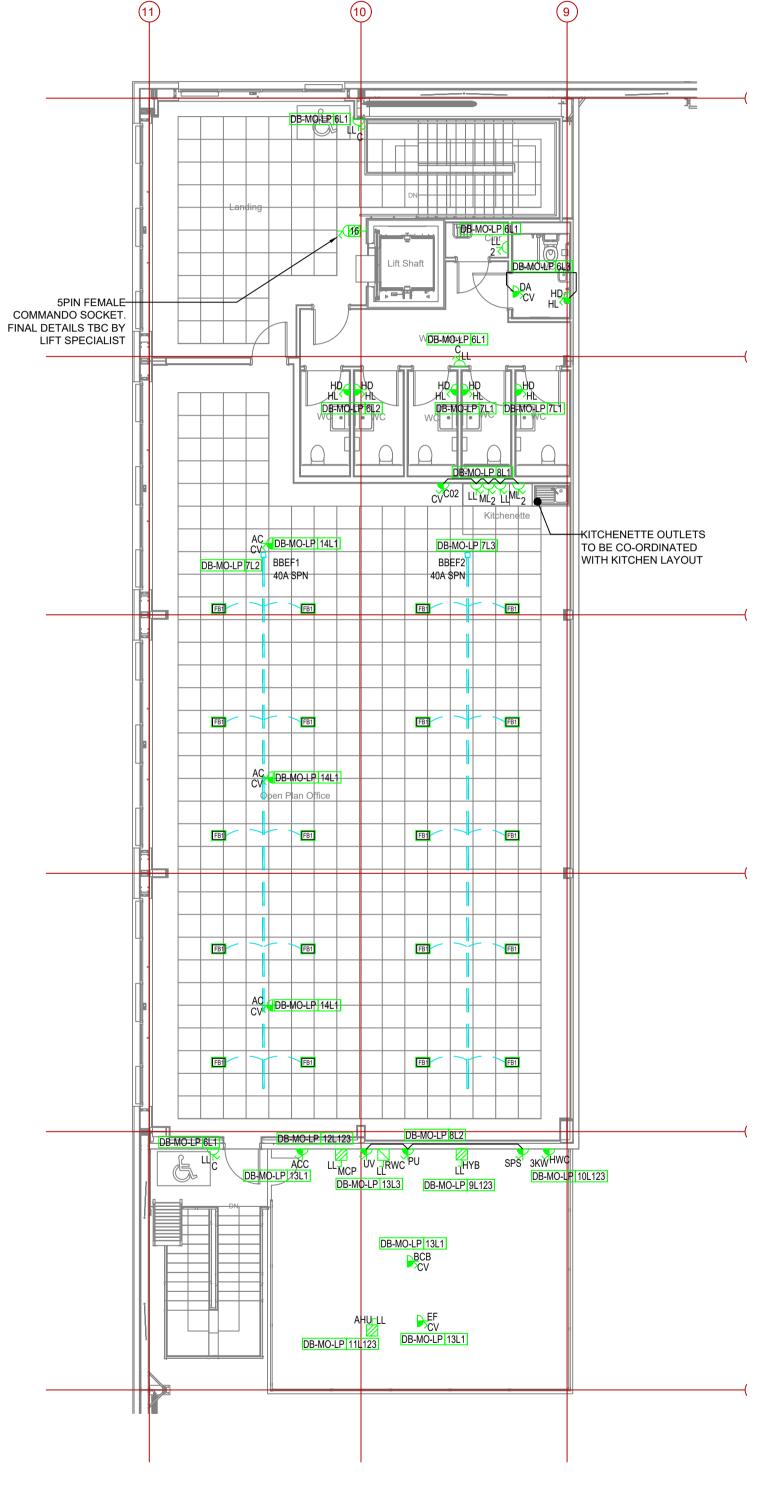

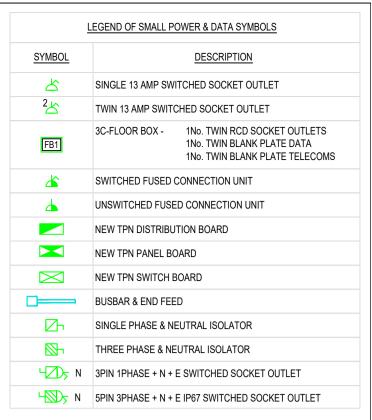

ACRONYMS	
AC	AIR CONDITIONING SYSTEM INDOOR UNIT
ACC	AC CENTRAL CONTROLLER
AD	AUTOMATIC DOOR
AHU	AIR HANDLING UNIT
BCB	AIR CONDITIONING SYSTEM BC BOX
С	CLEANERS SOCKET
CV	CEILING VOID
DA	DISABLED TOILET ALARM
DW	DISH WASHER
EF	EXTRACT FAN
EH	ELECTRICAL PANEL HEATER
EVCS	EMERGENCY VOICE COMMUNICATION SYSTEM P
FR	FRIDGE
FAP	FIRE ALARM PANEL
HB	HEATER BATTERY
HD	HAND DRYER
HDR	HAIR DRYER
HRU	HEAT RECOVERY UNIT
HWC	HWS CYLINDER
HYB	HYDROBOX
MC	METAL CLAD
MCP	MECHANICAL CONTROL PANEL
MW	MICROWAVE
PU	PRESSURISATION UNIT
RWC	RAINWATER HARVESTING COMBI UNIT
SH	SHOWER
SPS	SOLAR PUMP STATION
SV	SOLENOID VALVE
UV	RAINWATER HARVESTING UV FILTER

INSTALLATION HEIGHT ACRONYMS

LL LOW LEVEL (450MM FFL)

ML MID LEVEL (1200MM FFL)

HL HIGH LEVEL (2200MM FFL)

CV CEILING VOID

NOTES:
1. DO NOT SCALE FROM THE DRAWINGS.

2. ALL HAND DRYERS ARE TO BE PROVIDED BY OTHERS.

WATER HEATER

2. ALL HAND DRYERS ARE TO BE PROVIDED BY OTHERS.
3. DATA POINTS CONTAINMENT ONLY - WITH BLANK PLATES.







Project UNIT 3 WINGATES, BOLTON

UNIT 3 MAIN OFFICE
SMALL POWER LAYOUT


Scale	1:100	Drg. Size	A1	Date	18.10.2023
Drawn	LH	Checked	TW	Approved	XX
Drg. No.					Rev.
P2	3012-EE	3M-03-X	X-DR-E-(0330	AF


IM SCALE 1:100

 20mmØ CONDUIT RECESSED WITHIN WALL FOR FUTURE HAND DRYER INSTALLATION BY TENANT.

△ _{CEILING}

FLOOR

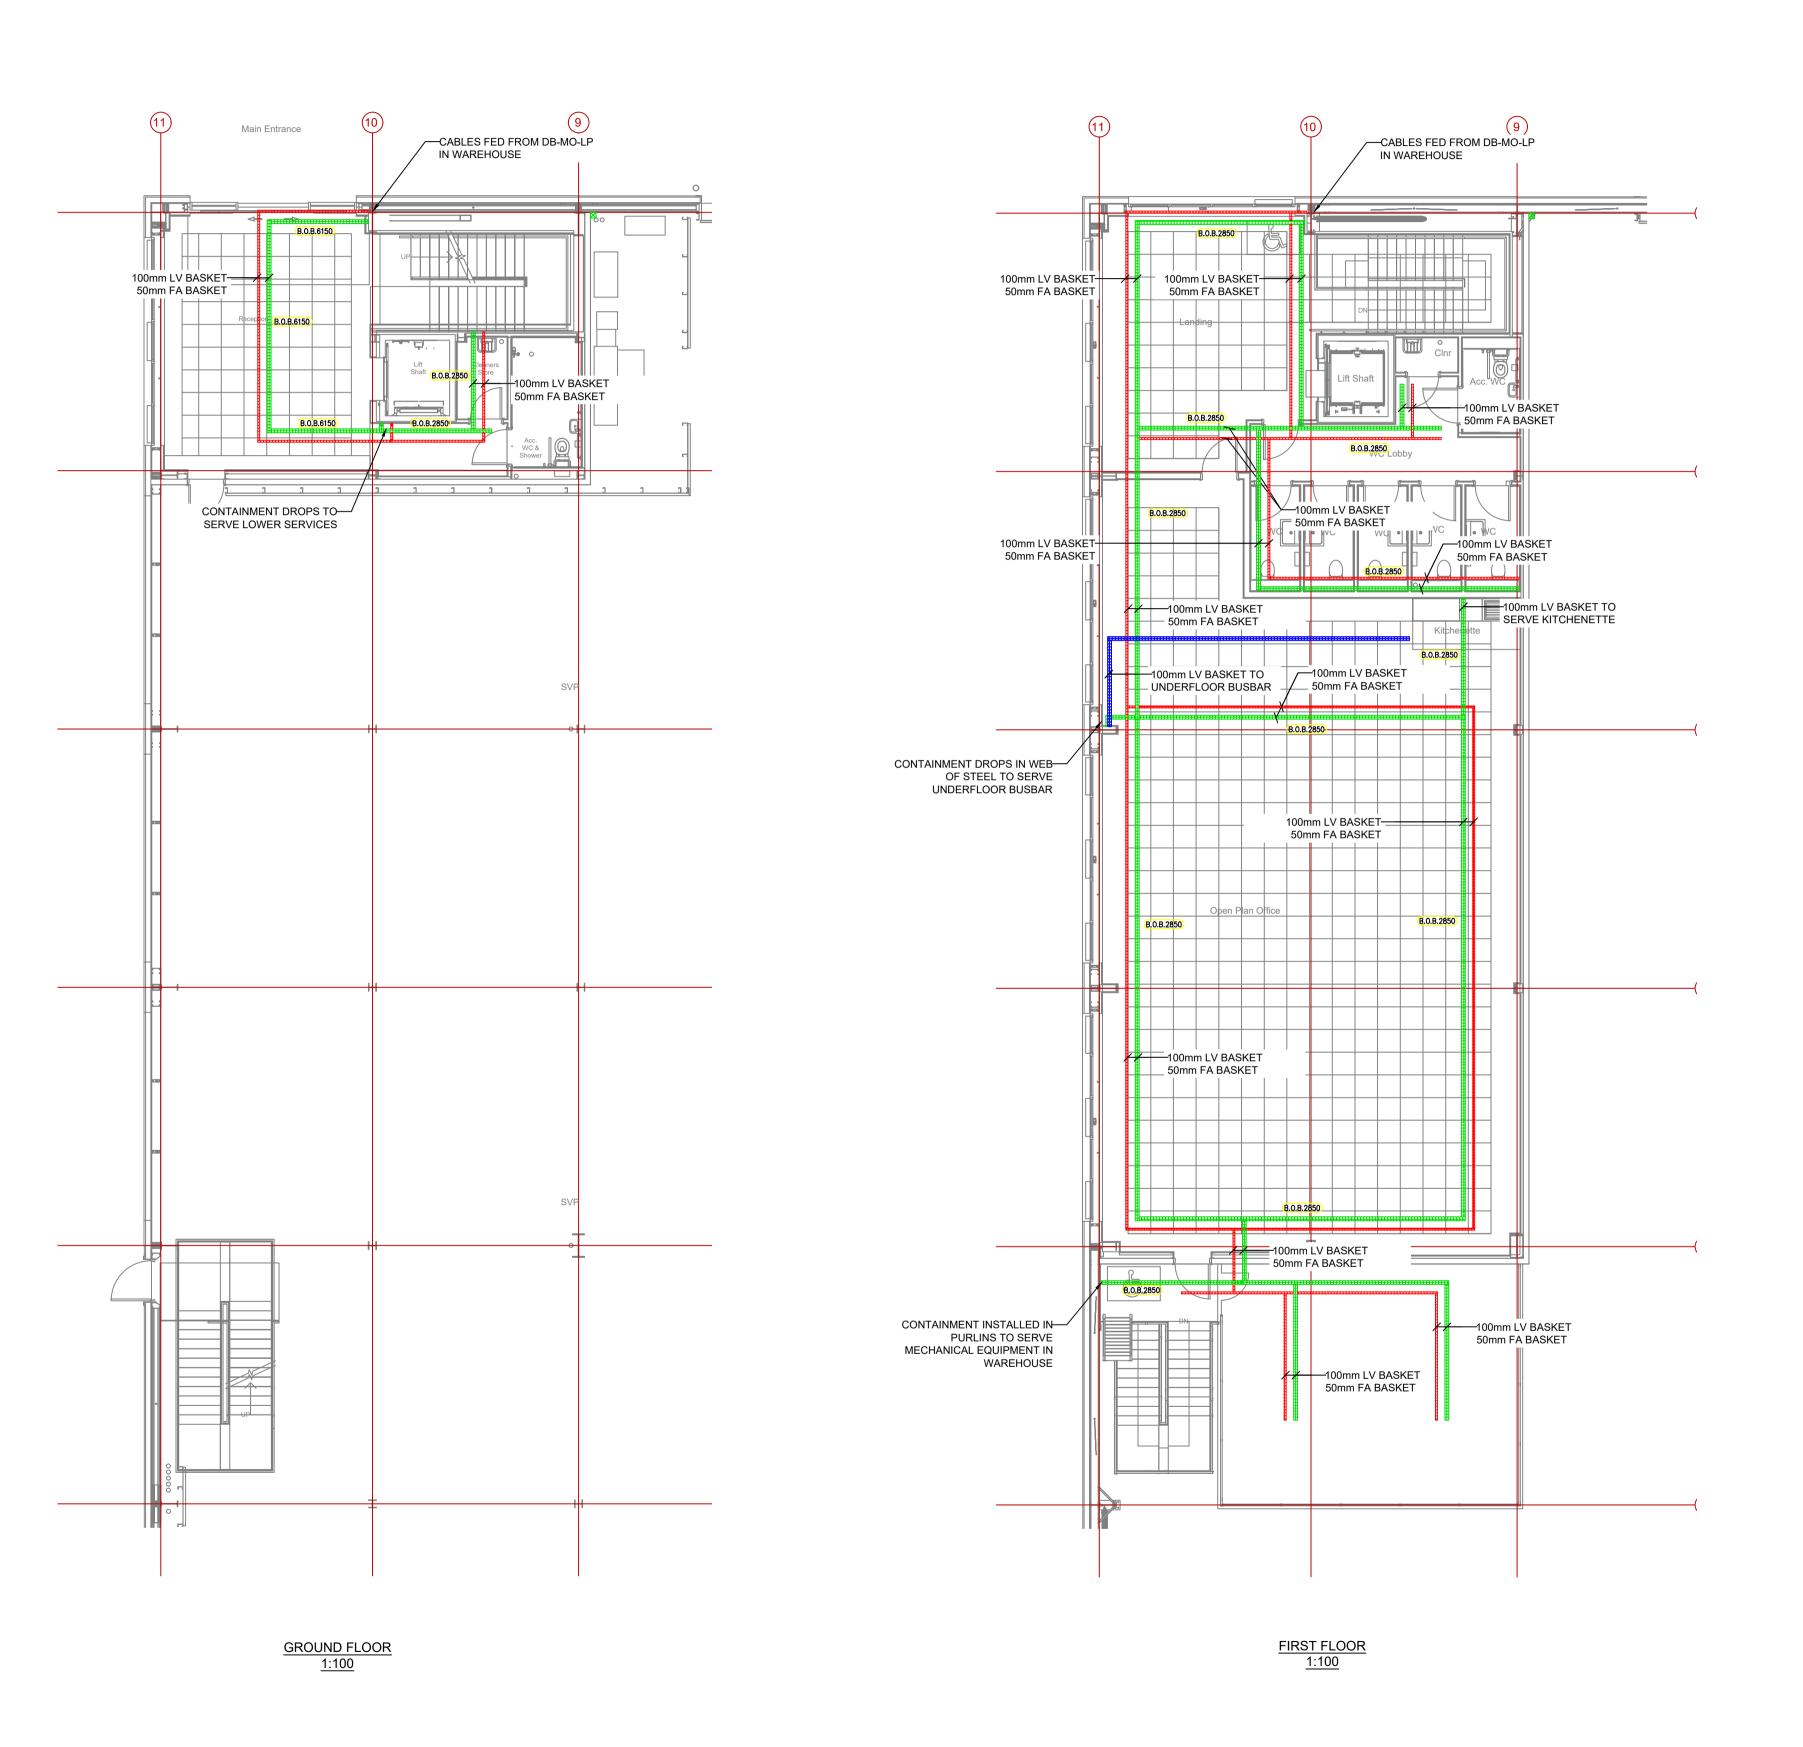

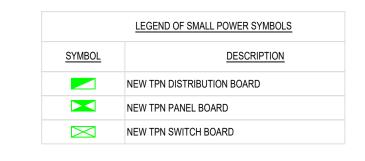

LE	EGEND OF CONTAINMENT SYMBOLS
SYMBOL	DESCRIPTION
	LV SUBMAINS CABLE LADDER, SIZE AS DENOTE
	LV SUBMAINS CABLE TRAY, SIZE AS DENOTED
	LV CABLE BASKET, SIZE AS DENOTED
	LV CABLE BASKET (UNDERFLOOR), SIZE AS DENOTED
•••••	FA CABLE BASKET, SIZE AS DENOTED
\bowtie	CONTAINMENT RISER / DROP

- DO NOT SCALE FROM THE DRAWING.
- 2. OFFICE AREAS ARE TO BE PROVIDED WITH HIGH IMPACT
- uPVC CONDUIT RECESSED WITHIN WALLS.

 3. WAREHOUSE/PLANT AREAS ARE TO BE PROVIDED WITH
- GALVANISED STEEL CONDUIT. 4. FIRE ALARM CABLING WILL BE CLIPPED DIRECT TO THE
- STRUCTURE, USING FIRE RATED CLIPS IN ANY AREAS WHERE NO DEDICATED CONTAINMENT IS INDICATED.
- 5. SUB-MAIN CABLING TO UTILISE THE BUILDING FABRIC (PURLINS) WHERE POSSIBLE.
 6. ALL CONTAINMENT PENETRATIONS THROUGH FIRE WALLS
- ARE TO BE MADE GOOD BY MAIN CONTRACTOR.
- 7. ALL FIRE ALARM/ELV CONTAINMENT TO BE A MINIMUM 200mm FROM LV CONTAINMENT.






Project UNIT 3 WINGATES, **BOLTON**


UNIT 3 MAIN OFFICE CONTAINMENT LAYOUT


Scale	1:100	Drg. Size	A1	Date	18.10.2023
Drawn	LH	Checked	TW	Approved	XX
Drg. No.					Rev.
P2	3012-EE	3M-03-X	X-DR-E-(0330	AF

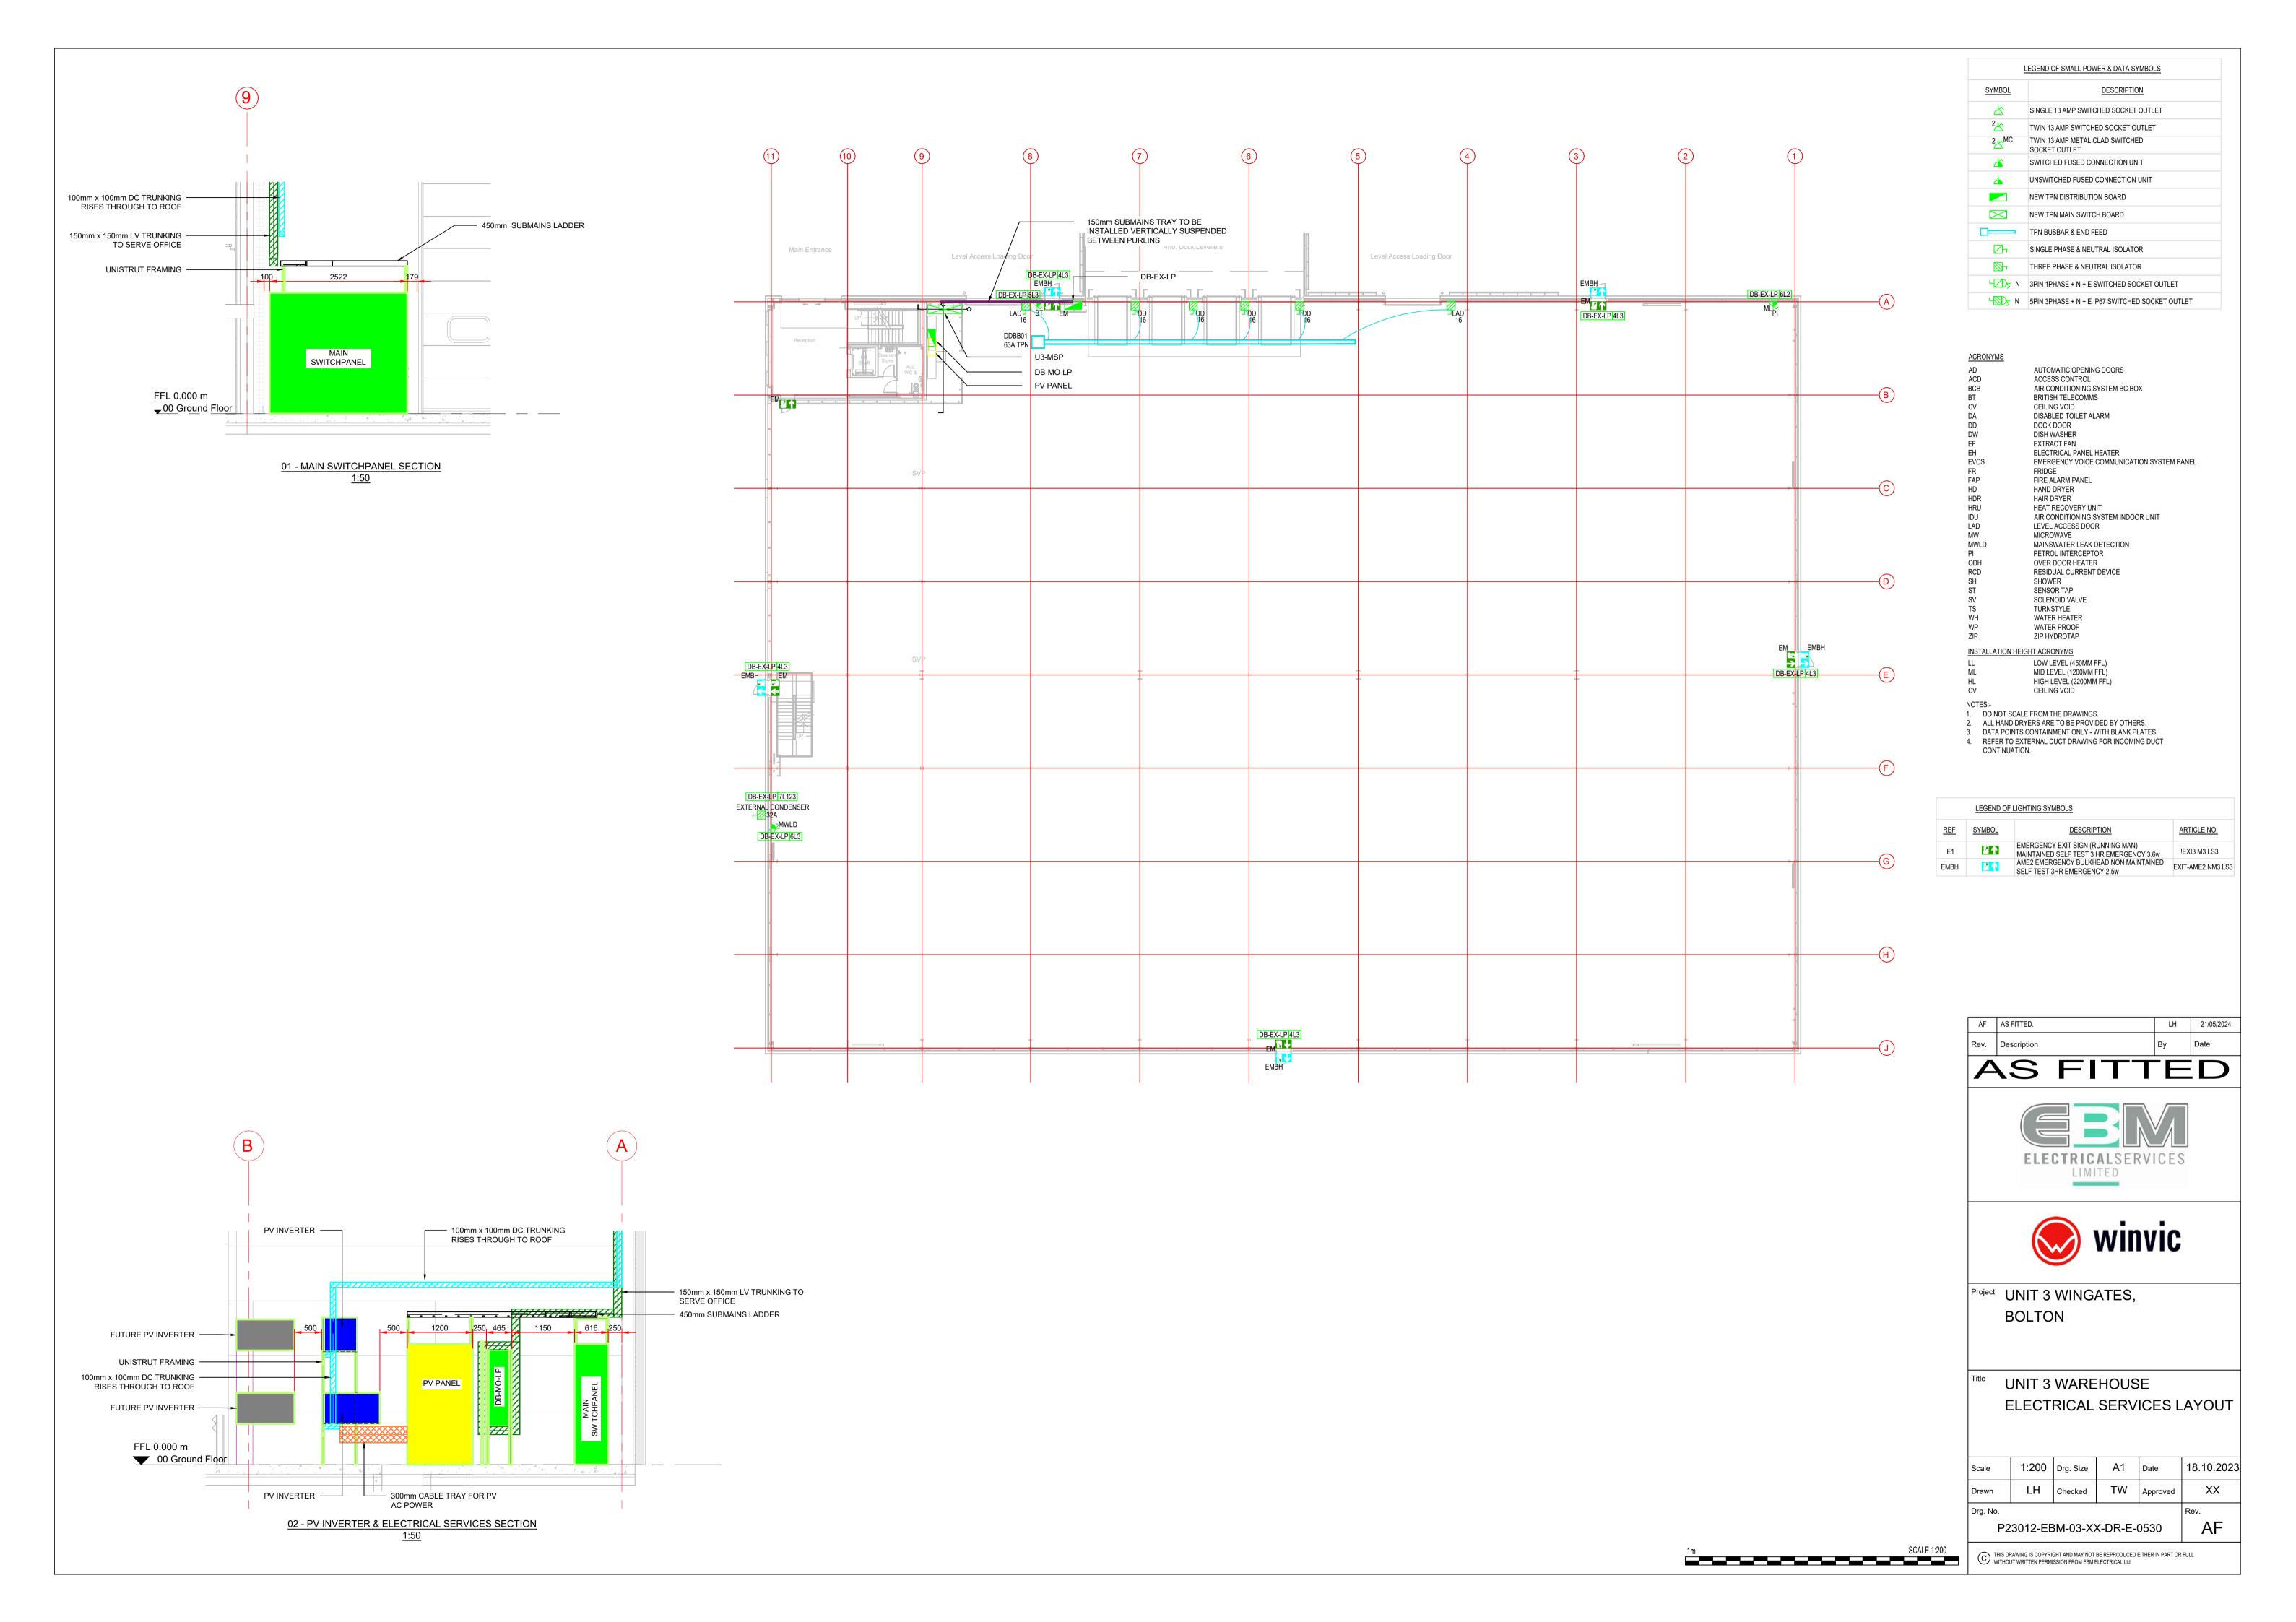

METER SCHEDULE				
REFERENCE	LOCATION	METERING	TYPE	
BM001	ACB ENCLOSURE	BILLING METER	TBC BY METER PROVIDER	
M001	MSP - INCOMING	MSP	HGR965 SERIES	
M002	MSP - OUTGOING	DDBB1	HGR965 SERIES	
M003	MSP - OUTGOING	LIFT	HGR965 SERIES	
M004	MSP - OUTGOING	PV PANEL	HGR965 SERIES	
M005	DB-MO-LP	DB-MO-LP (LIGHTING)	HGR43 SERIES	
M006	DB-MO-LP	DB-MO-LP (POWER)	HGR43 SERIES	
M007	DB-EX-LP	DB-EX-LP (LIGHTING)	HGR43 SERIES	
M008	DB-EX-LP	DB-EX-LP (POWER)	HGR43 SERIES	

CABLE REFERENCE	CABLE DETAIL	PROTECTION DEVICE DETAILS
MC001	7 X 1C 400MM² 90° THERMOSETTING NON-MAG XLPE/PVC/AWA/PVC CPC - 3 X 1C 70MM² 6491B GRN/YEL	SETTINGS TO BE PROVIDED BY ENWL.
MC002	2 X 1 X 4C 240MM² 90° THERMOSETTING XLPE/LSF/SWA/LSF CPC - 185MM² 6491B GRN/YEL	HAGER HW+ ACB HW1M - 55KA - 4P, LSI 800A Ir = 1.0, tr = 25.0, lsd = 4.0, l²t = OFF, tsd = 0.05, li = 15.0, MAX Zs - 0.0623Ω
SM001	1 X 1 X 4C 25MM² 90° THERMOSETTING XLPE/LSF/SWA/LSF CPC - ARMOURING	HAGER H3+ MCCB P160 - 40KA - 3-4P, LSnI 100A Ir1 = 100, Ir2 = 1.00, Isd = 7.0, tsd = 100, MAX Zs - 0.3656Ω
SM002	1 X 1 X 4C 25MM² 90° THERMOSETTING XLPE/LSF/SWA/LSF CPC - ARMOURING	HAGER H3+ MCCB P160 - 40KA - 3-4P, LSnI 160A @100A Ir1 = 100, Ir2 = 1.00, Isd = 7.0, tsd = 100, MAX Zs - 0.3656Ω
FC001	1 X 1 X 4C 6MM² 90° THERMOSETTING XLPE/LSF/SWA/LSF CPC - ARMOURING	HAGER H3+ MCCB P160 - 40KA - 3-4P, LSnI 100A @ 40A Ir1 = 44, Ir2 = 0.91, Isd = 7.0, tsd = 100, MAX Zs - 0.9131Ω
FC002	1 X 1 X 4C 6MM² 90° THERMOSETTING XLPE/LSF/SWA/LSF CPC - ARMOURING	HAGER H3+ MCCB P160 - 40KA - 3-4P, LSnI, 40A @ 16.4A Ir1 = 18, Ir2 = 0.91, Isd = 7.0, tsd = 100, MAX Zs - 1.7397Ω
FC003	1 X 1 X 3C 4MM² FP200 CPC - INTEGRAL	HAGER MCCB x160 HHA-E 1P 25KA FTFM TH/MAG 16A MAX Zs - 0.8706Ω
FC004	1 X 1 X 3C 4MM² FP200 CPC - INTEGRAL	HAGER MCCB x160 HHA-E 1P 25KA FTFM TH/MAG 16A MAX Zs - 0.8706Ω
FC005	1 X 1 X 4C 2.5MM² 90° THERMOSETTING XLPE/LSF/SWA/LSF CPC - INTEGRAL + ARMOURING	HAGER H3+ MCCB P160 - 40KA -3-4P, LSnI 40A @ 16.4A Ir1 = 18, Ir2 = 0.91, Isd = 2.0, tsd = 100, Ii = 15,MAX Zs - 6.088Ω
FC006	2 X 1 X 4C 185MM² 90° THERMOSETTING XLPE/LSF/SWA/LSF CPC - ARMOURING	HAGER H3+ MCCB P630 - 40KA - 3-4P, LSnI 630A @ 250A Ir1 = 250, Ir2 = 1.0, tr = 10.0, Isd = 3.0, I ² t = On, tsd = 50, Ii = 3, MAX Zs - 0.2659Ω

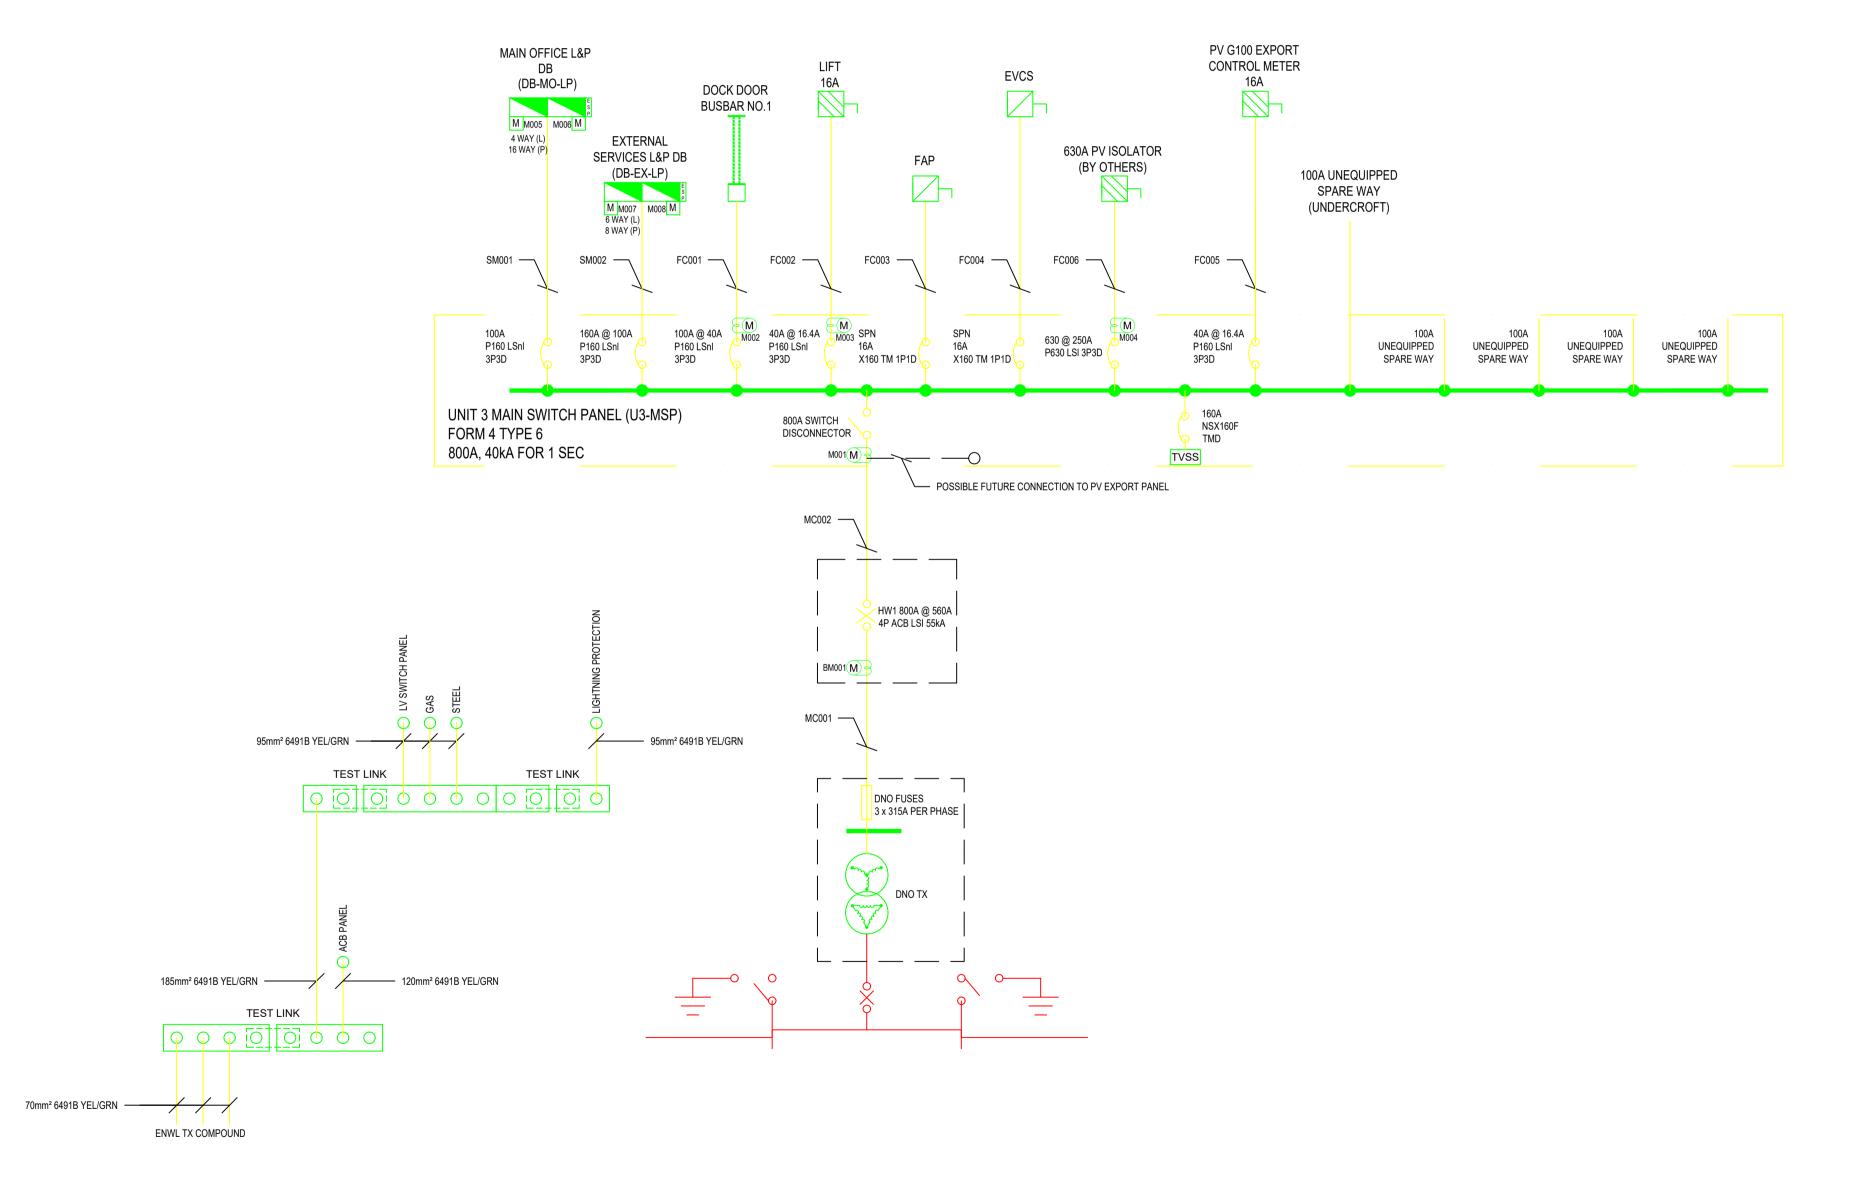

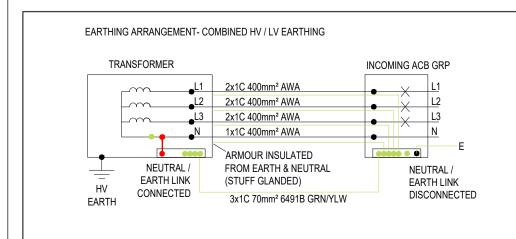

NOTES

- 1. DO NOT SCALE FROM THE DRAWING.
- ALL DISTRIBUTION BOARDS ARE TO BE TPN UNLESS STATED
 OTHERWISE
- 3. ALL MCCB's ARE TO BE TPN TYPE UNLESS STATED OTHERWISE
- 4. G99 RELAY INTEGRAL TO PV INVERTERS.
- 5. INCOMING ELECTRICAL SUPPLY TO UNIT 3 SHALL BE 550kVA
- 6. THE MAIN INCOMING PROTECTIVE DEVICE HAS BEEN SET IN ACCORDANCE WITH THE TOTAL LOAD IMPOSED ON THE MAIN LV PANEL BY BASEBUILD DEMAND AND CURRENT PV LOADS. FURTHER CONSIDERATION MAY BE REQUIRED TO THE TOTAL LOAD IMPOSED ON THE LV PANEL FOR FURTHER DEMAND AND / OR PV ADDED DURING FUTURE WORKS.

SYMBOL DESCRIPTION 11,000V / 400V TRANSFORMER ACB - RATING AS SHOWN MCCB - RATING AS SHOWN SWITCH DISCONNECTOR - RATING AS SHOWN FUSE - RATING AS SHOWN TPN DISTRIBUTION BOARD SPLIT METERED LIGHTING & POWER TPN DISTRIBUTION BOARD TPN BUSBAR TPN BUSBAR TPN ISOLATOR DOUBLE POLE KEYSWITCH METER c/w MODBUS CONNECTIVITY REF RESTRICTED EARTH FAULT RELAY TYPE 1 & 2 SURGE SUPPRESSION		
ACB - RATING AS SHOWN MCCB - RATING AS SHOWN SWITCH DISCONNECTOR - RATING AS SHOWN FUSE - RATING AS SHOWN TPN DISTRIBUTION BOARD SPLIT METERED LIGHTING & POWER TPN DISTRIBUTION BOARD TPN BUSBAR TPN ISOLATOR DOUBLE POLE KEYSWITCH METER c/w MODBUS CONNECTIVITY REF RESTRICTED EARTH FAULT RELAY	LEGEND	OF POWER SYMBOLS
ACB - RATING AS SHOWN MCCB - RATING AS SHOWN SWITCH DISCONNECTOR - RATING AS SHOWN FUSE - RATING AS SHOWN TPN DISTRIBUTION BOARD SPLIT METERED LIGHTING & POWER TPN DISTRIBUTION BOARD TPN BUSBAR TPN BUSBAR TPN ISOLATOR DOUBLE POLE KEYSWITCH METER c/w MODBUS CONNECTIVITY REF RESTRICTED EARTH FAULT RELAY	SYMBOL	DESCRIPTION
MCCB - RATING AS SHOWN SWITCH DISCONNECTOR - RATING AS SHOWN FUSE - RATING AS SHOWN TPN DISTRIBUTION BOARD SPLIT METERED LIGHTING & POWER TPN DISTRIBUTION BOARD TPN BUSBAR TPN BUSBAR DOUBLE POLE KEYSWITCH METER c/w MODBUS CONNECTIVITY RESTRICTED EARTH FAULT RELAY		11,000V / 400V TRANSFORMER
SWITCH DISCONNECTOR - RATING AS SHOWN FUSE - RATING AS SHOWN TPN DISTRIBUTION BOARD SPLIT METERED LIGHTING & POWER TPN DISTRIBUTION BOARD TPN BUSBAR TPN BUSBAR TPN ISOLATOR DOUBLE POLE KEYSWITCH METER c/w MODBUS CONNECTIVITY REF RESTRICTED EARTH FAULT RELAY	<u> </u>	ACB - RATING AS SHOWN
FUSE - RATING AS SHOWN TPN DISTRIBUTION BOARD SPLIT METERED LIGHTING & POWER TPN DISTRIBUTION BOARD TPN BUSBAR TPN BUSBAR DOUBLE POLE KEYSWITCH METER c/w MODBUS CONNECTIVITY REF RESTRICTED EARTH FAULT RELAY	C	MCCB - RATING AS SHOWN
TPN DISTRIBUTION BOARD SPLIT METERED LIGHTING & POWER TPN DISTRIBUTION BOARD TPN BUSBAR TPN ISOLATOR DOUBLE POLE KEYSWITCH METER c/w MODBUS CONNECTIVITY REF RESTRICTED EARTH FAULT RELAY	0	SWITCH DISCONNECTOR - RATING AS SHOWN
SPLIT METERED LIGHTING & POWER TPN DISTRIBUTION BOARD TPN BUSBAR TPN ISOLATOR DOUBLE POLE KEYSWITCH METER c/w MODBUS CONNECTIVITY REF RESTRICTED EARTH FAULT RELAY		FUSE - RATING AS SHOWN
TPN DISTRIBUTION BOARD TPN BUSBAR TPN ISOLATOR DOUBLE POLE KEYSWITCH METER c/w MODBUS CONNECTIVITY REF RESTRICTED EARTH FAULT RELAY		TPN DISTRIBUTION BOARD
TPN ISOLATOR DOUBLE POLE KEYSWITCH METER c/w MODBUS CONNECTIVITY REF RESTRICTED EARTH FAULT RELAY	M M	
DOUBLE POLE KEYSWITCH METER c/w MODBUS CONNECTIVITY REF RESTRICTED EARTH FAULT RELAY		TPN BUSBAR
METER c/w MODBUS CONNECTIVITY REF RESTRICTED EARTH FAULT RELAY		TPN ISOLATOR
REF RESTRICTED EARTH FAULT RELAY		DOUBLE POLE KEYSWITCH
	⊘ M	METER c/w MODBUS CONNECTIVITY
TVSS TYPE 1 & 2 SURGE SUPPRESSION	REF	RESTRICTED EARTH FAULT RELAY
	TVSS	TYPE 1 & 2 SURGE SUPPRESSION
ESP LOCAL DB 2 SURGE SUPPRESSION	ESP	LOCAL DB 2 SURGE SUPPRESSION
O_O EMERGENCY POWER OFF BUTTON	0_0	EMERGENCY POWER OFF BUTTON






Project UNIT 3 WINGATES, BOLTON

LV SCHEMATIC

	Scale	NTS	Drg. Size	A1	Date	26.09.23
	Drawn	LH	Checked	TW	Approved	TW
	Drg. No.					Rev.
	P23	012-EBN	Л-03-ZZ-	DR-E-00	00830	AF
Λ		•			•	

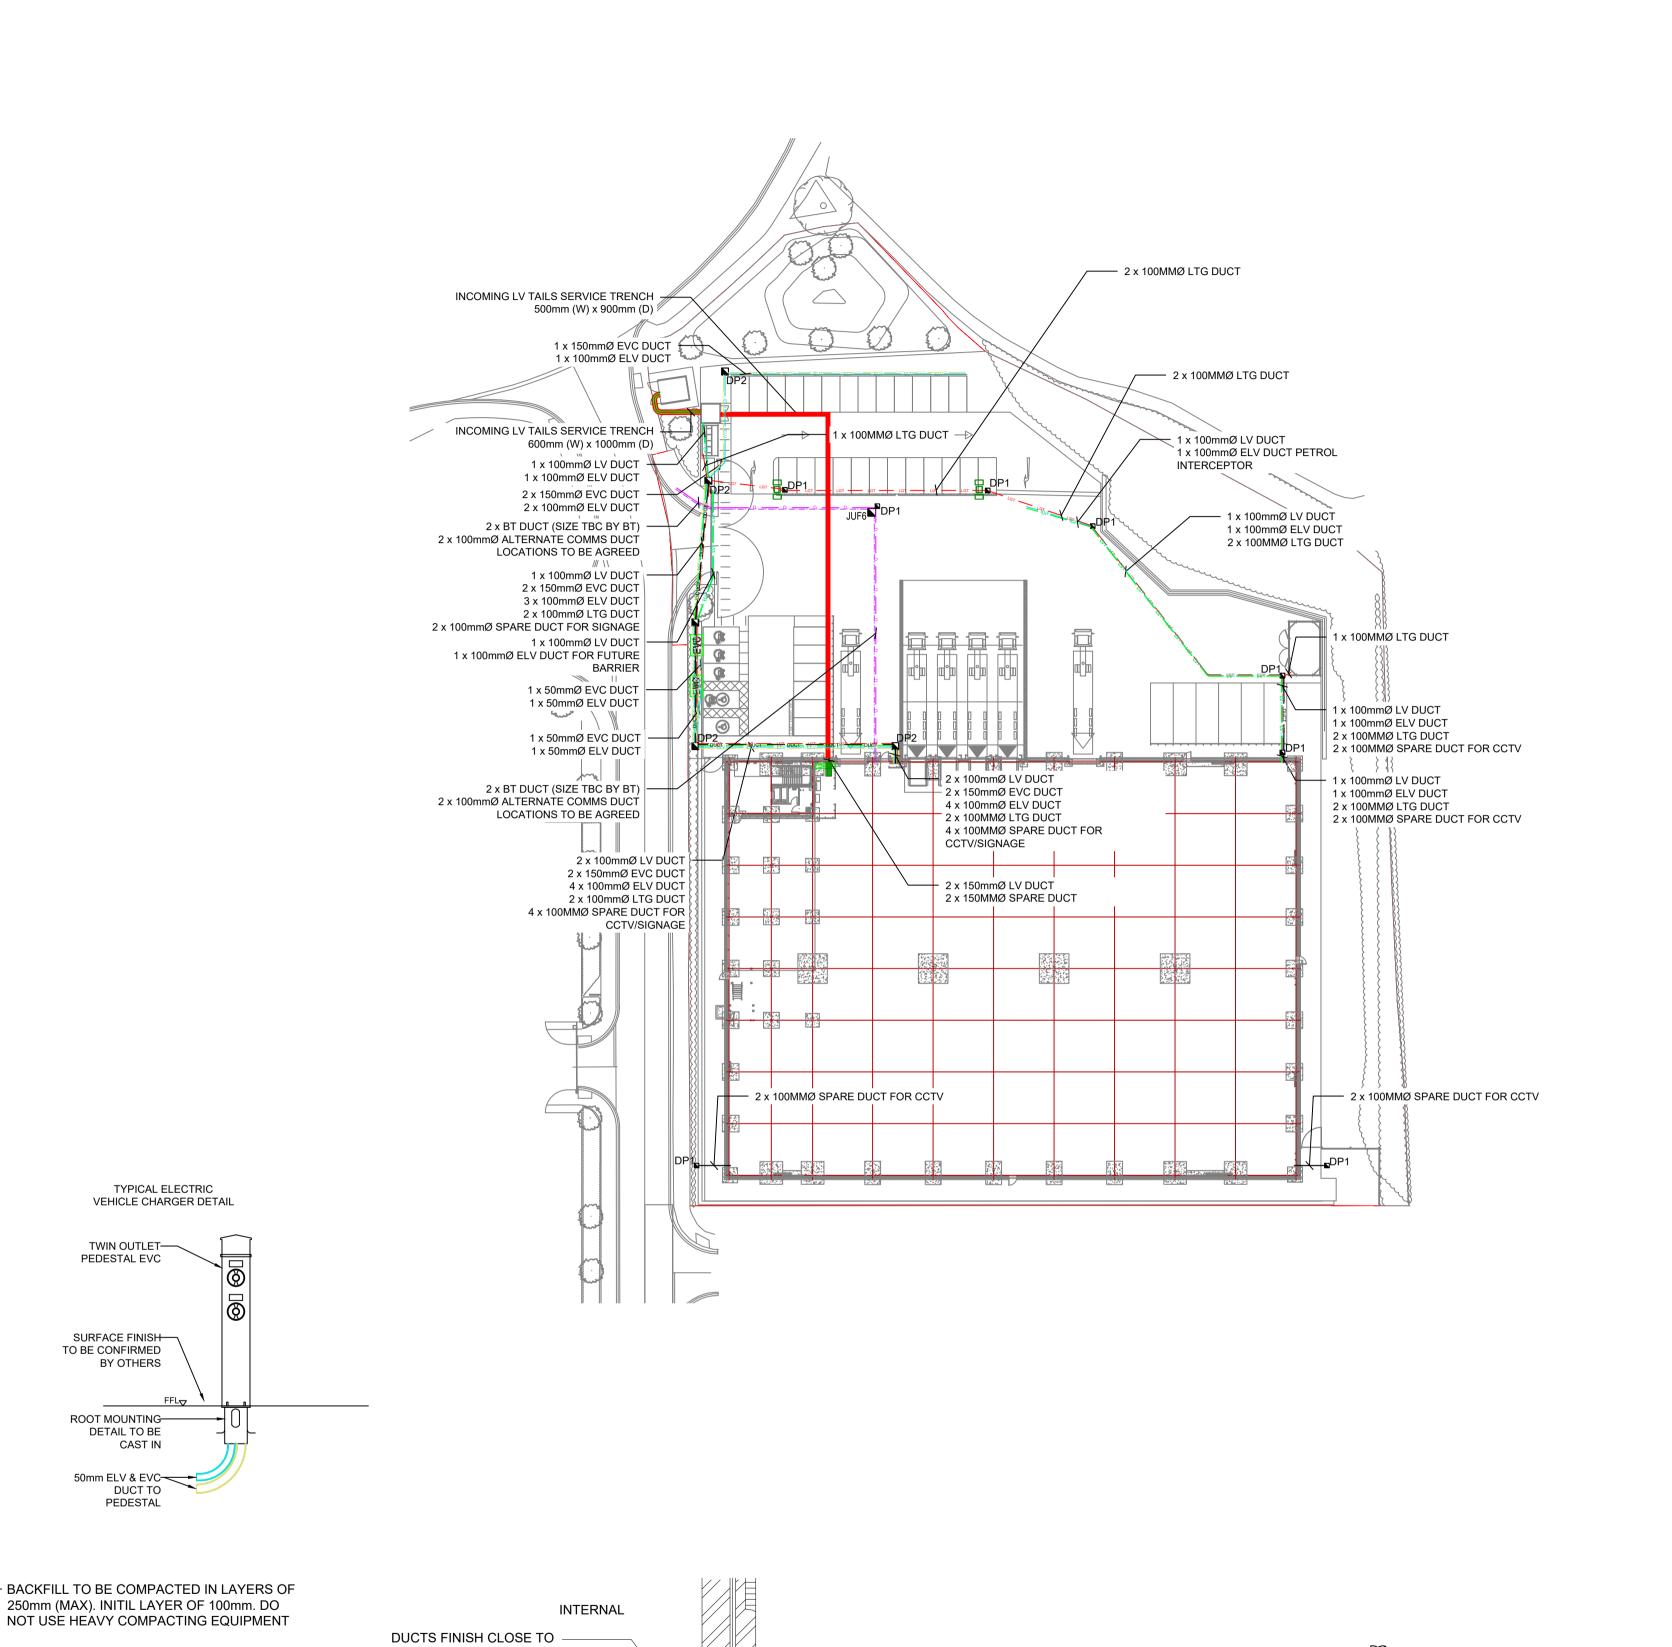

LEGEND OF EXTERNAL LIGHTING SYMBOLS SYMBOL DESCRIPTION 6m EXTERNAL LIGHTING COLUMN

LEGEND OF POWER SYMBOLS SYMBOL DESCRIPTION EVC ELECTRIC VEHICLE CHARGER

LEGE	ND OF EXTERNAL DUCT SYMBOLS
SYMBOL	DESCRIPTION
DUCT	SPARE DUCT
—— вт ——	BT DUCT (BT SPECIFICATION)
LV	LV DUCT
LGT LGT	LV LIGHTING DUCT
ELV	ELV DUCT
EVC2 EVC2	EVC DUCT
D	ALTERNATIVE COMMS/DATA DUCT
■ DP1	DRAW PIT (600mm x 600mm)
■DP2	DRAW PIT (900mm x 900mm)
■ DP3	DRAW PIT (1000mm x 1000mm)
■JUF6	BT PIT - EXACT DETAILS TBC BY BT

LEGEND OF SMALL POWER & DATA SYMBOLS					
SYMBOL	DESCRIPTION				
	NEW TPN DISTRIBUTION BOARD				

NOTES

- 1. DO NOT SCALE FROM THE DRAWING.
- ALL HV / LV CABLE DUCTS ARE TO HAVE SLOW RADIUS BENDS. 3. ALL DUCTS ARE TO BE LEFT WITH DRAW CORDS FOR EASE OF FUTURE CABLE PULLING.
- 4. ALL DUCTS AND BELOW GROUND SERVICES ARE TO BE INSTALL IN ACCORDANCE WITH THE NJUG STANDARD DEPTHS.
- 5. ALL DRAW PITS ARE TO BE HEAVY DUTY TYPE TO WITHSTAND THE
- ASSOCIATED VEHICLE TRAFFIC, DEPENDING UPON AREA. 6. ALL EXTERNAL LIGHTING COLUMNS TO BE PROVIDED WITH
- PRE-FORMED DEMOUNTABLE POLE CHAMBER SYSTEMS WHICH COMBINE COLUMN CHAMBER AND CABLE CHAMBER FOR EASE OF
- WIRING AND MAINTENANCE. 7. ALL BT DUCTING AND CHAMBERS TO BE INSTALLED TO BT
- SPECIFICATION AND STANDARDS. 8. ALL HV / LV CABLING ARE PROVIDED WITH THE NECESSARY WARNING
- MARKER TAPES. 9. ALL BELOW GROUND DUCTING IS TWIN WALL TYPE COMPLETE WITH
- SMOOTH INTERIOR.





ELECTRICALSERVICES


LIMITED

Project UNIT 3 WINGATES, BOLTON

UNIT 3 EXTERNAL SERVICES LAYOUT

Scale	1:500	Drg. Size	A1	Date	16.10.2023
Drawn	LH	Checked	TW	Approved	XX
Drg. No.		•			Rev.
P2	P23012-EBM-EX-XX-DR-E-0930				

THIS DRAWING IS COPYRIGHT AND MAY NOT BE REPRODUCED EITHER IN PART OR FULL WITHOUT WRITTEN PERMISSION FROM EBM ELECTRICAL Ltd.

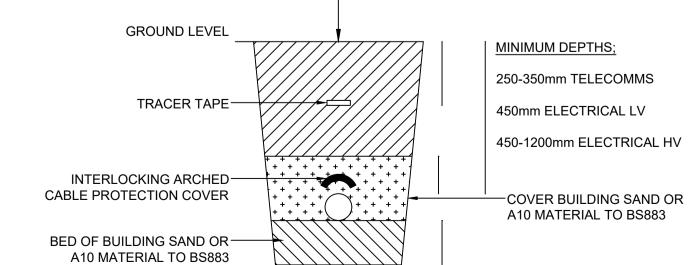

OUTGOING

DUCTS

INCOMING

DUCTS

TYPICAL LIGHTING COLUMN AND

DRAW PIT PLAN 'DETAIL 1'

LIGHTING — COLUMN

1x50mm (MIN) LV DUCT -

TO LIGHTING COLUMN

TYPICAL ELECTRIC

VEHICLE CHARGER DETAIL

TWIN OUTLET-PEDESTAL EVC

SURFACE FINISH-TO BE CONFIRMED BY OTHERS

ROOT MOUNTING-


DETAIL TO BE CAST IN

50mm ELV & EVC

PEDESTAL

DUCT TO




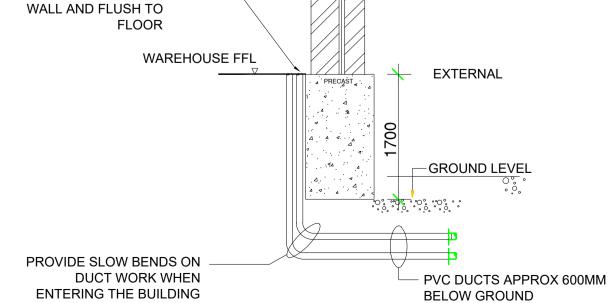

TYPICAL INCOMING CABLE DUCT ENTRY

INTO BUILDING



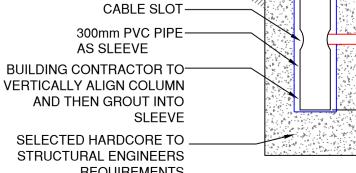

REQUIREMENTS

DEPTH OF SURFACE FINISH

TYPICAL LIGHTING COLUMN AND DRAW PIT SECTION 'DETAIL A'

——1x50mm (MIN) LV DUCT

TO LIGHTING COLUMN

INCOMING

DUCTS

DRAW PIT

DEPTH OF ROOT MOUNTED COLUMN (D)

in accordance with column

— LID TO SUIT TRAFFIC

REQUIREMENTS






D-SERIES 0 LUMINAIRE REFERENCE 'EX2'






DENVER ID WALL REFERENCE 'EX3 & EX4'

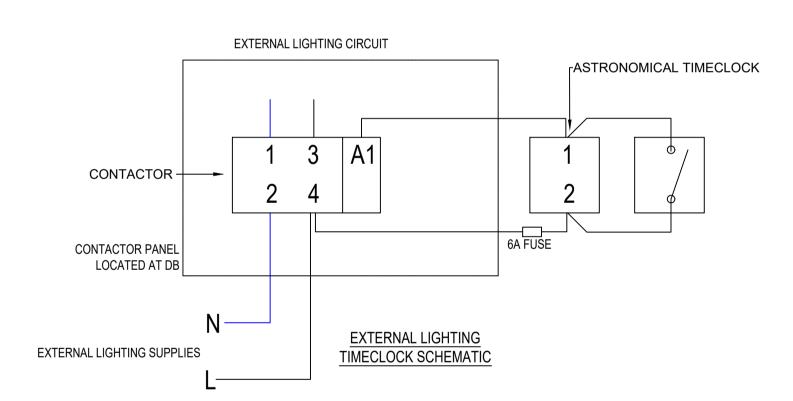


	LUX PLOT LEGEND			
SYMBOL	DESCRIPTION	<u>AVG</u>	MIN	MIN/AVG
+	CYCLE STORAGE	17 LUX	16 LUX	0.94
+	ENTRANCE (50 AVE 0.4 Uo)	51 LUX	48 LUX	0.94
+	LOADING BAYS (50 AVE 0.4 Uo)	54 LUX	46 LUX	0.85
+	PARKING MAIN (10 AVE 0.25 Uo)	22 LUX	10 LUX	0.45
+	PARKING OUTSIDE RECEPTION (10 AVE 0.25 Uo)	27 LUX	10 LUX	0.37
+	PARKING VANS (10 AVE 0.25 Uo)	35 LUX	21 LUX	0.60
+	PERIMETER (10 AVE 0.25 Uo)	11 LUX	3 LUX	0.27
+	SERVICE YARD (30 AVE 0.4 Uo)	32 LUX	13 LUX	0.41
+	SITE ENTRANCE (10 AVE 0.4 Uo)	12 LUX	7 LUX	0.58
+	SPILL LIGHT	1 LUX	0 LUX	0.00

EXTERNAL LIGHTING COLUMN SLEEVE DETAILS						
SLEEVE SIZE	HOLE IN SLEEVE HALF WAY UP					
800mm LONG 300mm WIDE	100mm					
1000mm LONG 400mm WIDE	100mm					
1200mm LONG 400mm WIDE	100mm					
1600mm LONG 450mm WIDE	100mm					
1700mm LONG 450mm WIDE	100mm					
	SLEEVE SIZE 800mm LONG 300mm WIDE 1000mm LONG 400mm WIDE 1200mm LONG 400mm WIDE 1600mm LONG 450mm WIDE					

	LEGEND OF EXTERNAL LIGHTING SYMBOLS				
SYMBOL	DESCRIPTION	QUANTITY	WEIGHTS	LLM/W	WINDAGE
EX1 🔀	200W (22000LM) D-SERIES 1 LUMINAIRE WITH FORWARD THROW OPTIC, WALL MOUNTED AT 8M - DSX1.2.LA224.FW - HOLOPHANE	4	12.2 kg	110	0.09
EX2	162W (10000LM) D-SERIES 0 LUMINAIRE WITH FORWARD THROW OPTIC, TWIN HEAD COLUMN MOUNTED AT 6M - DSX0.1.LA104.FW.BLS- HOLOPHANE	2	8.0 kg	123	0.09
ЕХЗ 🗀	11W (2000LM) DENVER ID WALL WITH LONG AND NARROW THROW OPTIC, WALL MOUNTED AT 5M - DWL.1.LA024.NR.W011 - HOLOPHANE	2	6.5 kg	135	N/A
EX4 🔀	6.5W (1000LM) DENVER ID WALL WITH LONG AND NARROW THROW OPTIC C/W PIR , WALL MOUNTED AT 3.5M - DWL.1.LA014.NR.W007.PL0 - HOLOPHANE	10	6.5 kg	127	N/A

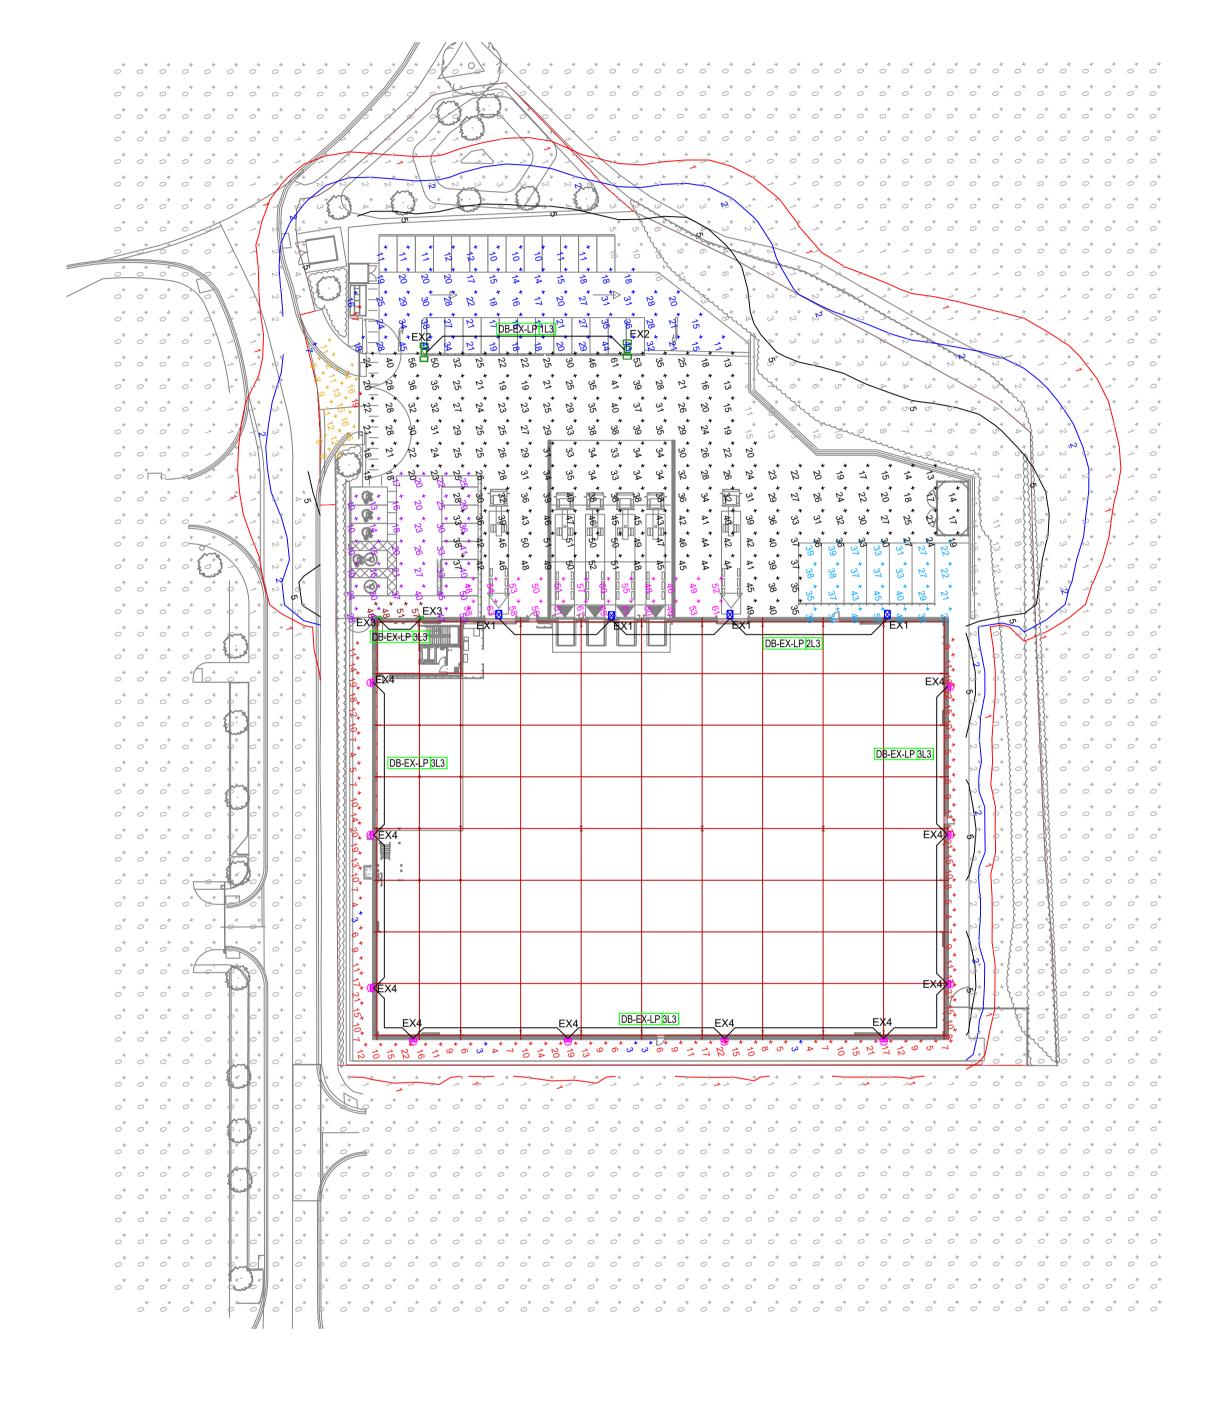

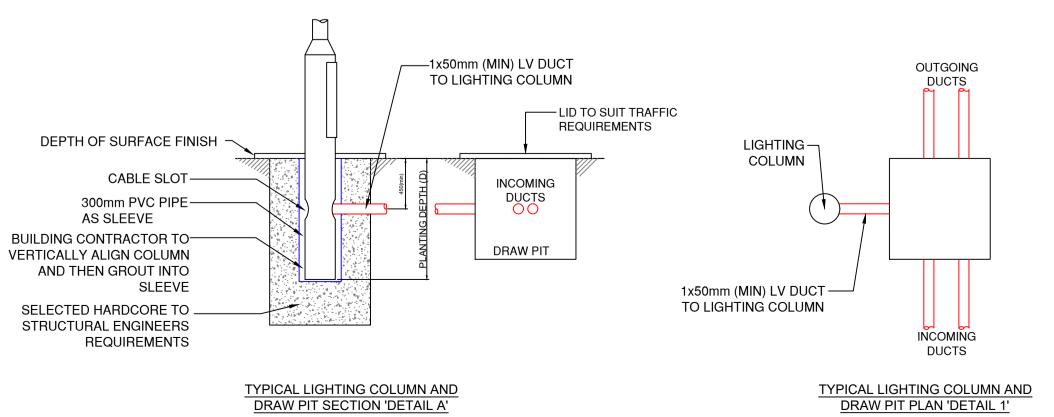

 DO NOT SCALE FROM THE DRAWING.
 ALL EXTERNAL LIGHTING COLUMNS ARE TO BE PROVIDED WITH PRE-FORMED DEMOUNTABLE POLE CHAMBER SYSTEM WHICH COMBINE COLUMN AND CABLE

COMPLETE WITH MANUAL OVERRIDE SWITCH. TIME SETTING DETAILS TBC ON SITE.

ALL LV CABLING DUCTS ARE TO HAVE SLOW RADIUS BENDS.
 EXTERNAL LIGHTING IS TO BE OPERATED BY ASTRONOMICAL TIME CLOCK

CHAMBER FOR EASE OF WIRING AND MAINTENANCE.

AF AS FITTED.

Rev. Description

By Date

AS FITTED

AS FITTED







Project UNIT 3 WINGATES,
BOLTON


UNIT 3 EXTERNAL LIGHTING & LUX PLOT LAYOUT

Scale	1:500	Drg. Size	A1	Date	02.11.2023
Drawn	LH	Checked	TW	Approved	XX
Drg. No.					Rev.
P2	3012-EB	BM-EX-X	X-DR-E-	0931	AF
					-

SCALE 1:500

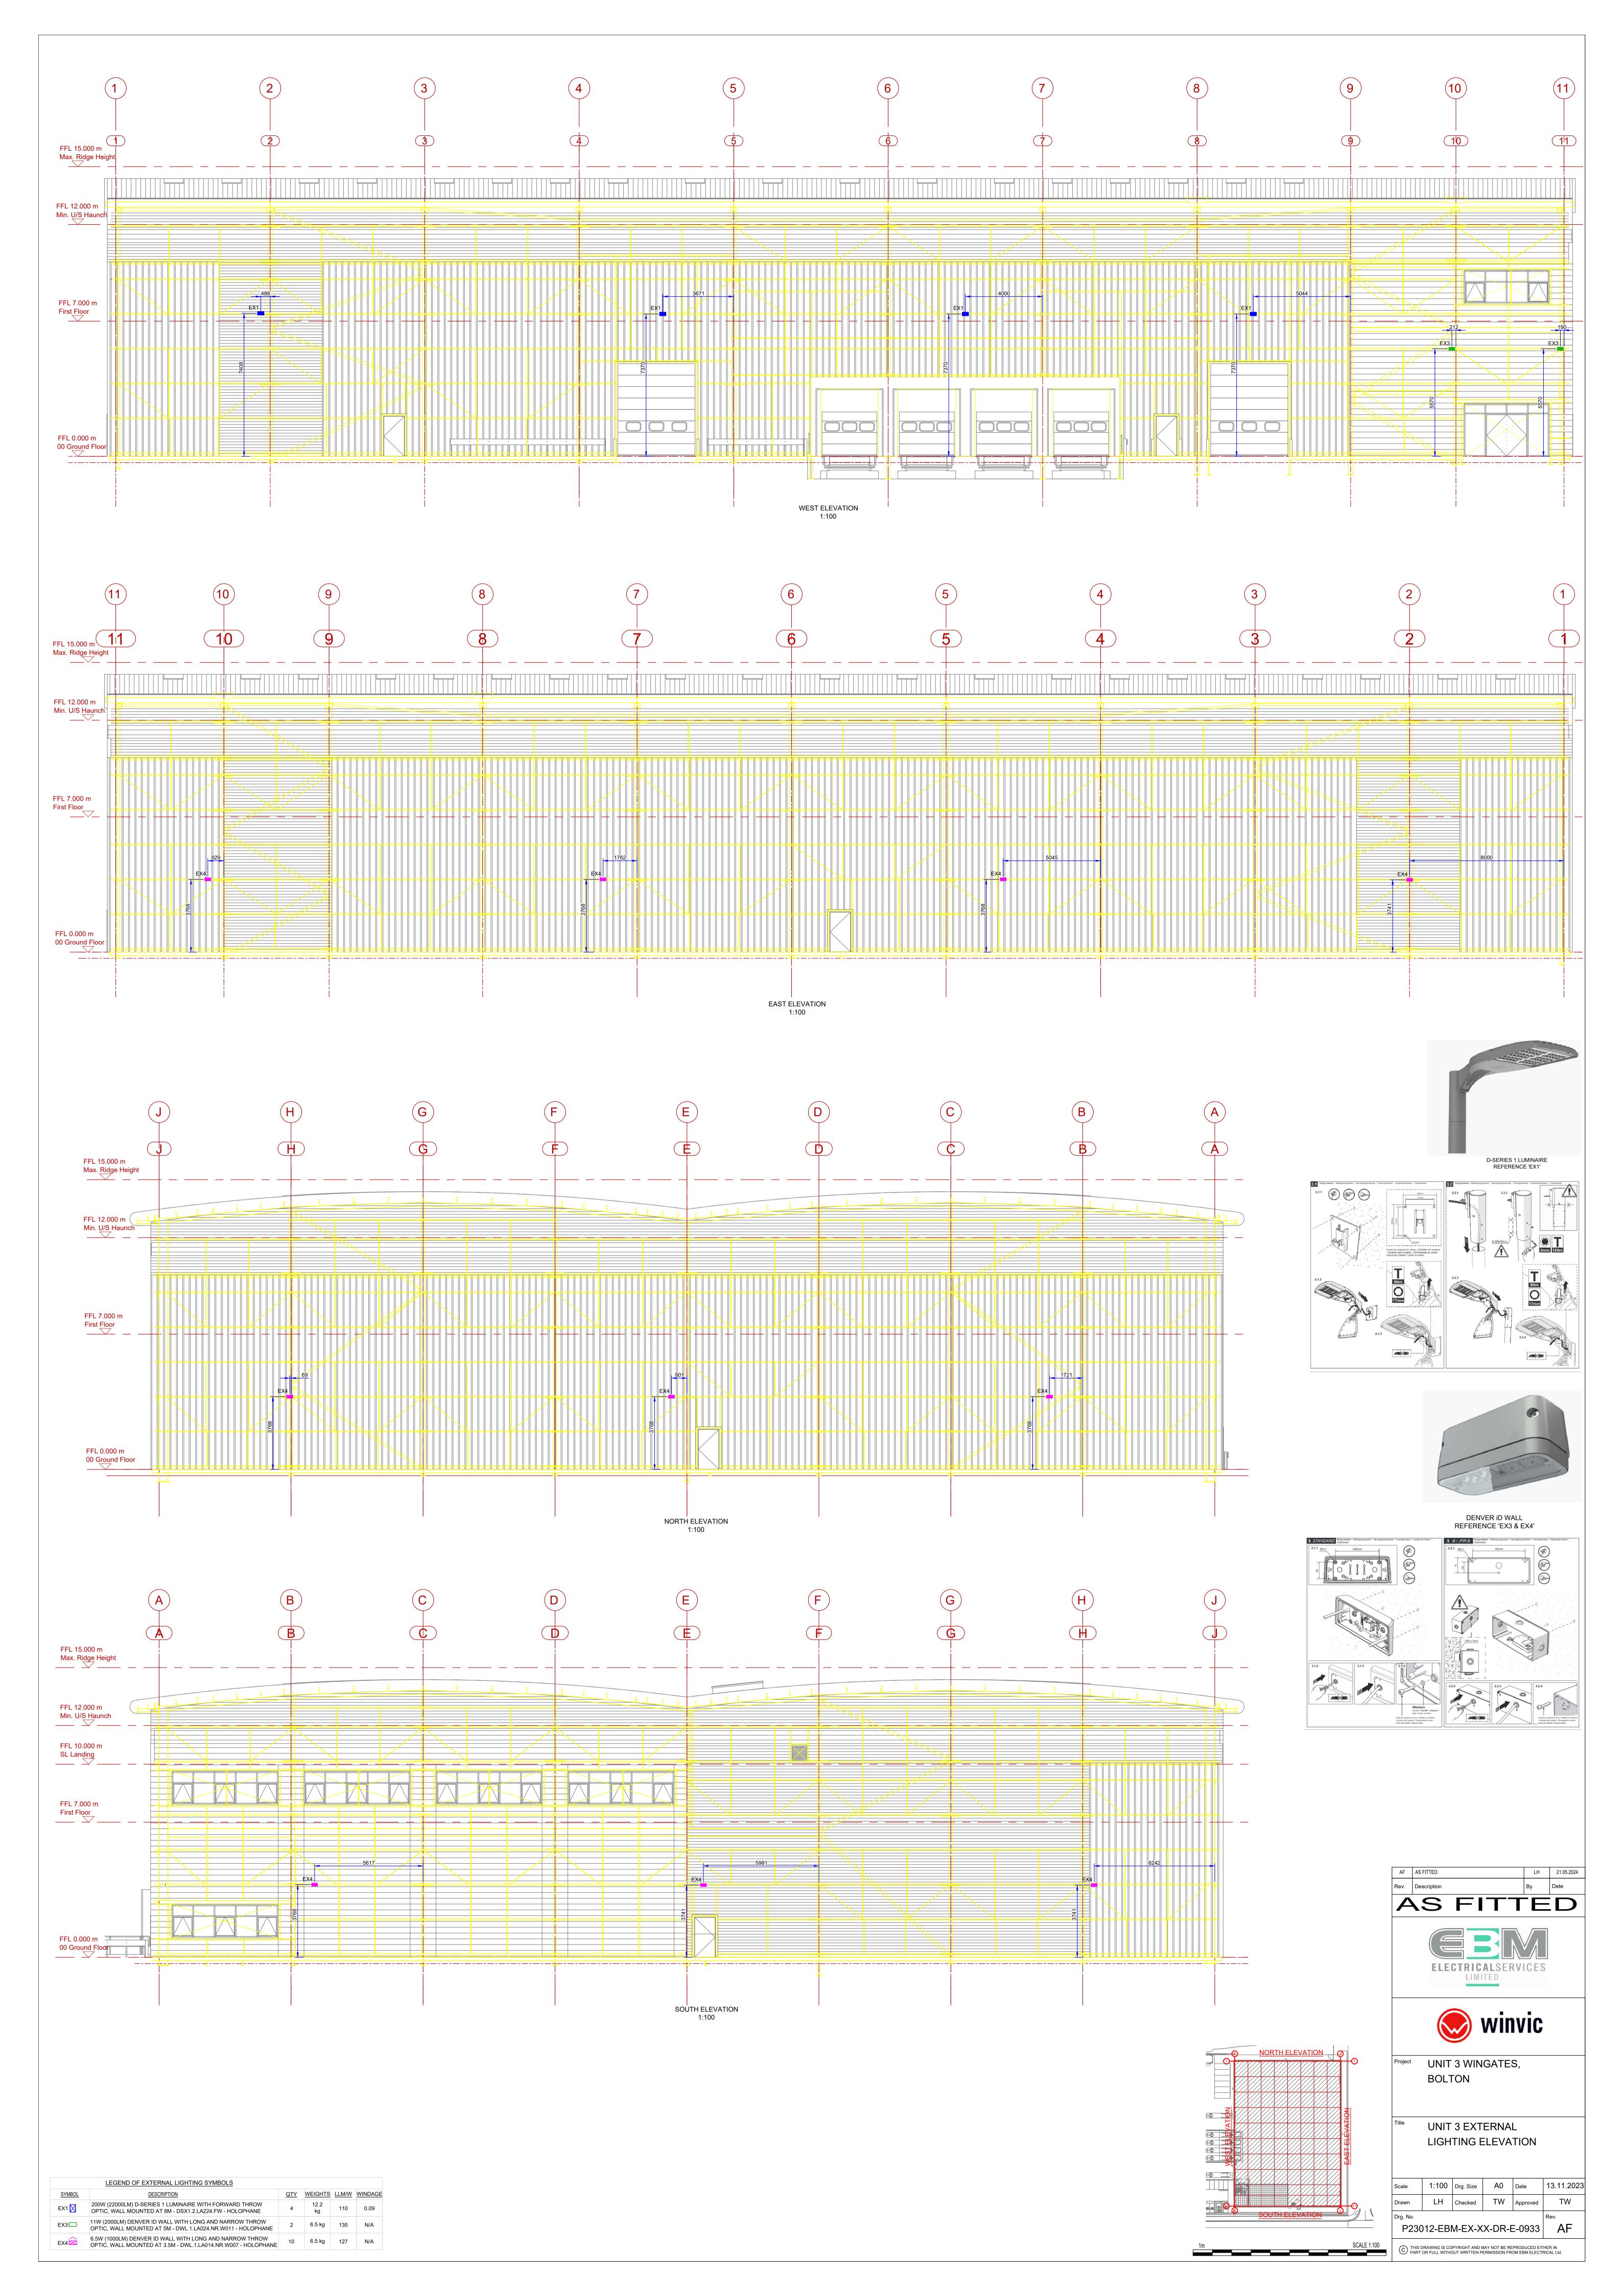

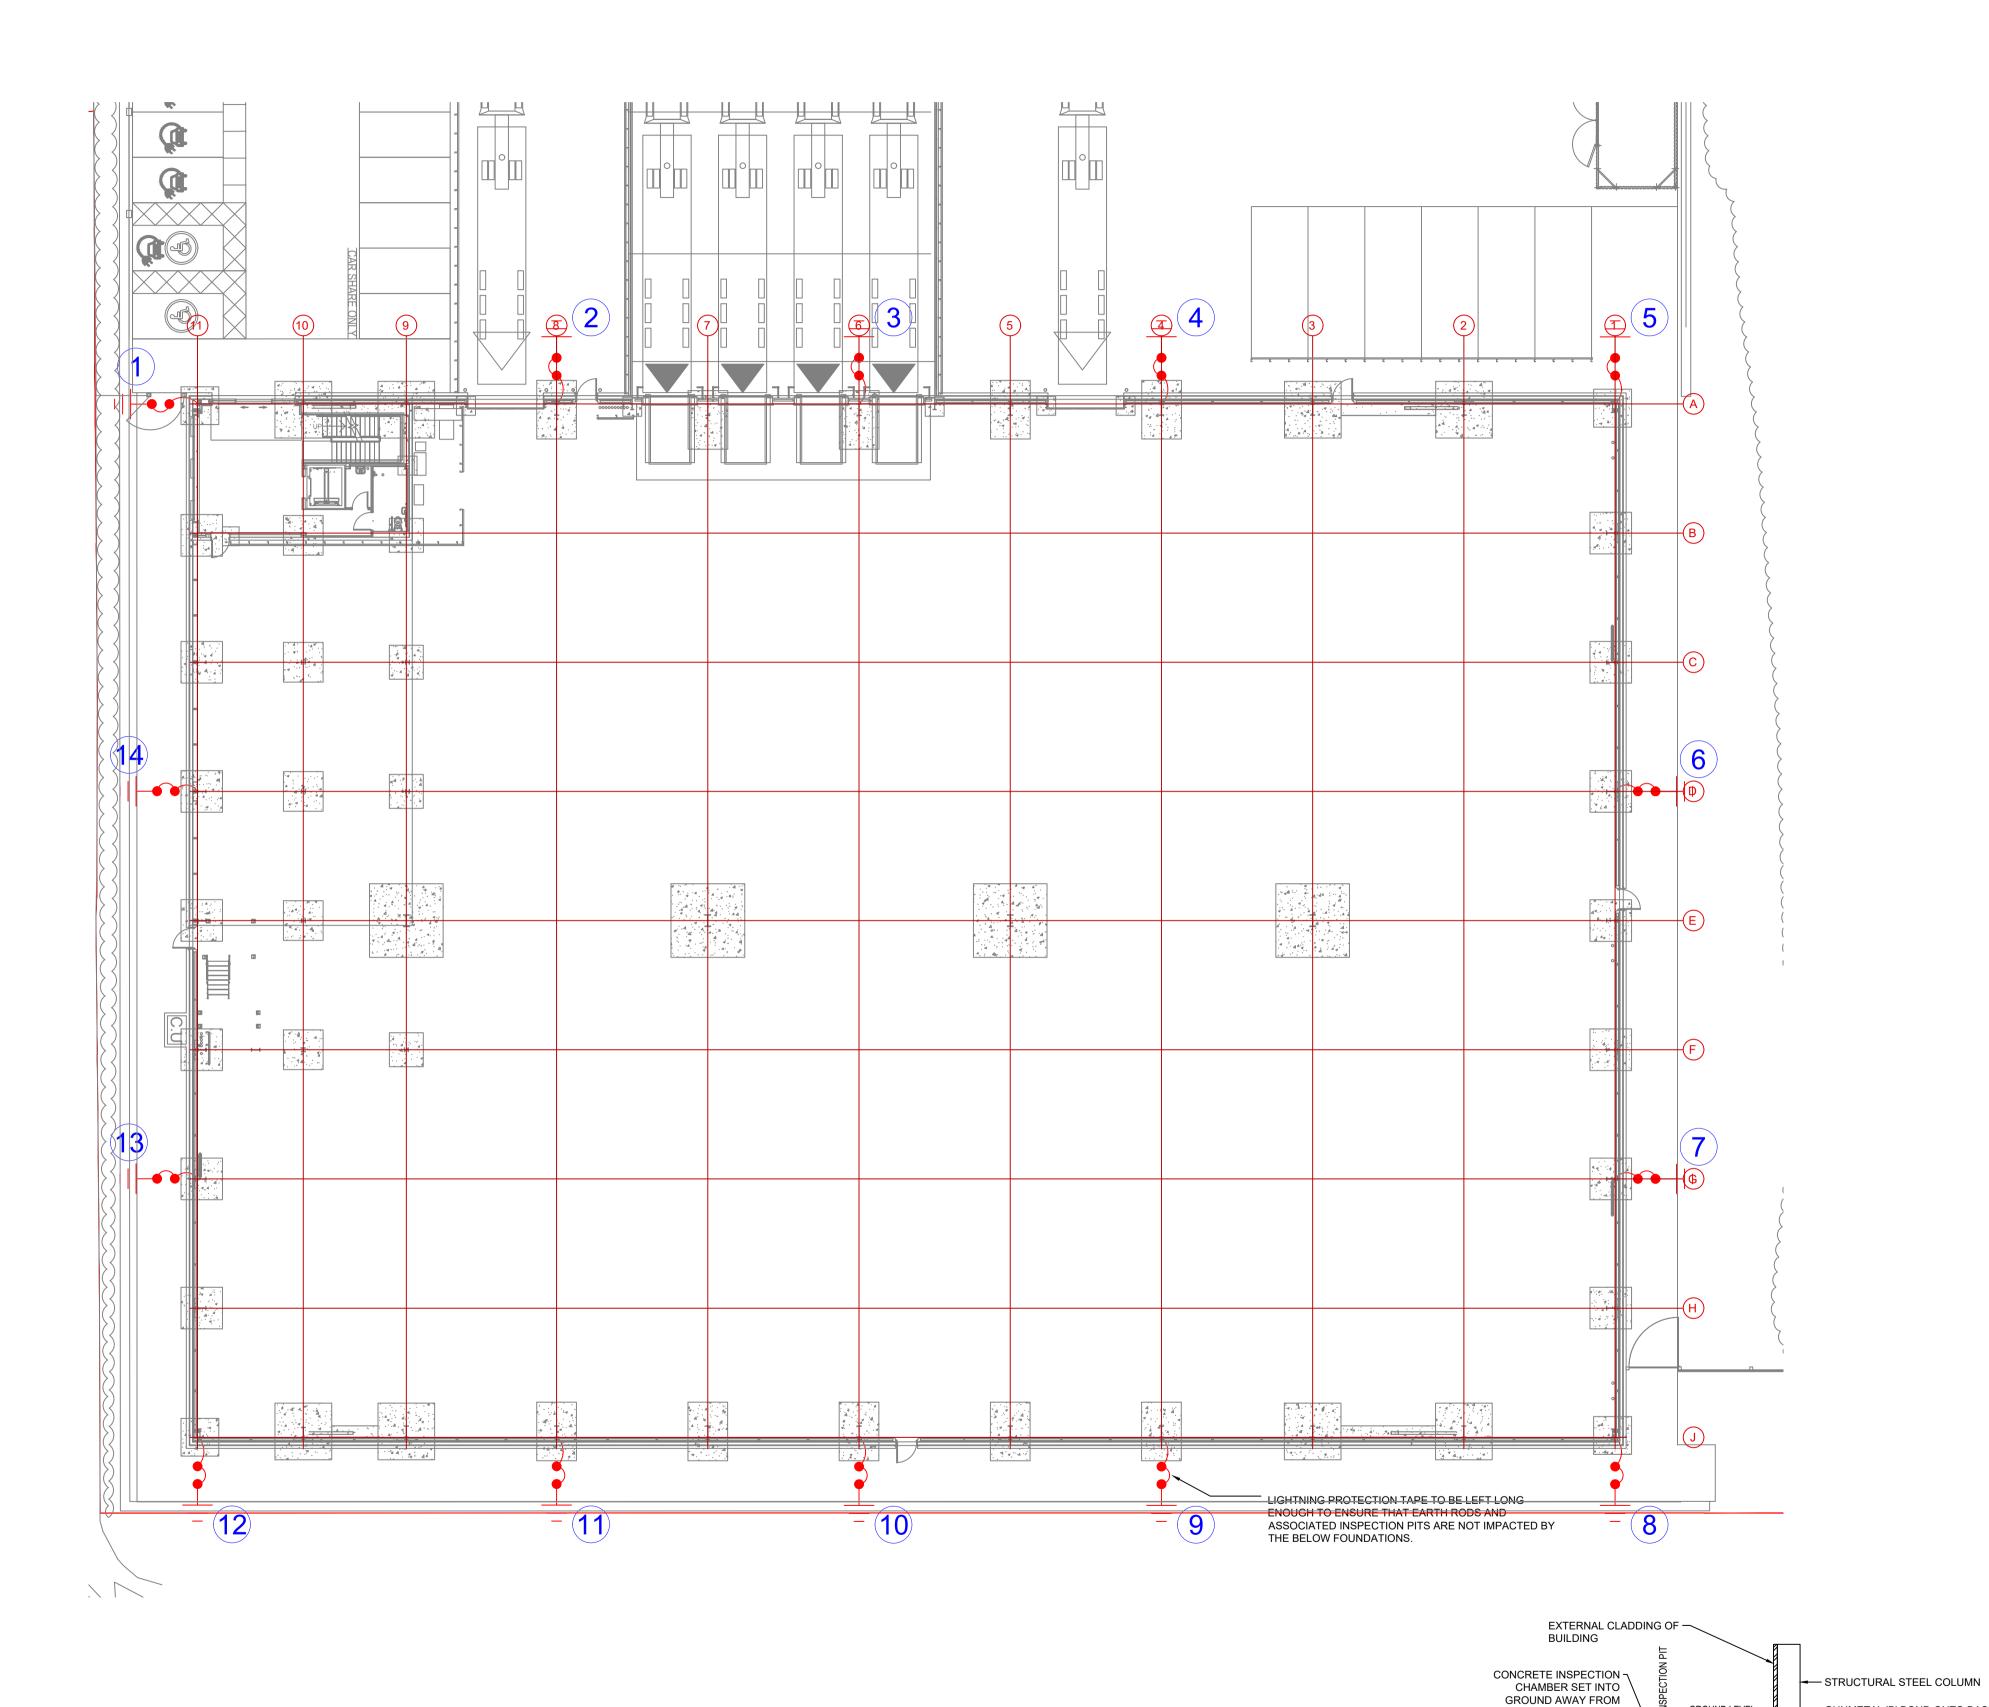

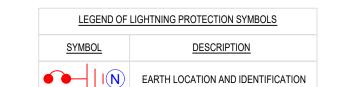

NOTES

- STRUCTURAL LIGHTNING PROTECTION SCHEME DESIGNED AND INSTALLED TO LEVEL IV OF BS EN 62305:2011.
- AIR TERMINATION NETWORK CONSISTS OF UTILISED BUILDING FABRIC.
- 3. DOWN CONDUCTORS NETWORK CONSIST OF UTILISED
- 4. TEST POINTS TO BE VIA INSPECTION PITS.

METALLIC STRUCTURE.

- 5. EARTH TERMINATION NETWORK CONSISTS OF 2.4M X 16MM COPPERBOND EARTH RODS COMPLETE WITH POLYMER INSPECTION PITS.
- LIGHTNING PROTECTION TAPE TO BE LEFT LONG ENOUGH TO ENSURE THAT EARTH RODS AND ASSOCIATED INSPECTION PITS ARE NOT IMPACTEDBY THE BELOW FOUNDATIONS.







Project UNIT 3 WINGATES,
BOLTON

GROUND LEVEL GUNMETAL 'B' BOND ONTO BASE OF COLUMN

L 25X3 PVC COVERED COPPER

TERMINATE ONTO EARTH ROD AWAY FROM FOOTINGS

TAPE - LONG ENOUGH TO

DETAIL 1 INSPECTION PIT EARTH CONNECTION ONTO STRUCTURAL STEEL COLUMN — COLUMN FOOTING

— CONCRETE ENCASEMENT OF BASE OF COLUMN

FOOTING

16MM DIAMETER — -

DEPTH 2400MM

GUNMETAL 'A' CLAMP

EARTH ROD - MINIMUM

UNIT 3 STRUCTURAL LIGHTNING PROTECTION LAYOUT

- 1						
	Scale	1:200	Drg. Size	A1	Date	16.10.2023
	Drawn	LH	Checked	TW	Approved	XX
	Drg. No.					Rev.
	P2	3012-EB	M-EX-X	X-DR-E-	0934	AF

NJUG Guidelines on the Positioning and Colour Coding of Underground Utilities' Apparatus

TABLE 1 - Recommended Colour Coding of Underground Utilities Apparatus All depths are from the surface level to the crown of the apparatus

Utility	Duct	Pipe	Cable	Marker Systems	Recommended Minimum Depths		
					Footway/Verge	Carriageway	
Electricity HV	Black or	N/A	Red or	Yellow with black	450-1200mm	750-1200mm	
(High Voltage)	red duct		black	and red legend			
	or tile			or concrete tiles			
Electricity LV	Black or	N/A	Black	Yellow with	450mm	600mm	
(Low Voltage)	red duct or		or red	black legend			
	tile			_			
Gas	Yellow	*** See row below	N/A	Black legend on	600mm footway	750mm	
				PE pipes every	750mm verge		
				linear metre.			
	*** PE - up	to 2 bar - yellow or yellow v	vith brown str	pes (removable skin	revealing white or b	lack core pipe).	
		tween 2 to 7 bar -orange.					
		ipes may have yellow wrap	or black tar c	pating or no coating.			
		Iron may have plastic wrap					
		os & Pit / Spun Cast Iron N		hable colour			
Water non Potable	N/A	Black with green stripes		N/A	600 - 750mm	600 - 750mm	
& Grey Water	14//-	Black With green daiped	14/73	13/73	000 - 70011111	000 - 700111111	
Water -	N/A	Black with red stripes or	N/A	N/A	600 - 750mm	600 - 750mm	
Firefighting	14//5	bands	13/73	IN/A	000 - 7 0011111	000 - 7 3011111	
Oil / fuel	N/A	Black	N/A	Various surface	900mm	900mm	
pipelines	IN/A	DIACK	N/A				
pipelines				markers	All work within	All work within	
					3 metres of oil	3 metres of oil	
				Marker tape or	fuel pipelines	fuel pipelines	
				tiles above red	must receive	must receive	
				concrete	prior approval	prior approval	
Sewerage	Black	No distinguishing colour	N/A	N/A	Variable	Variable	
		/ material (eg: Ductile					
		Iron may be red; PVC					
		may be brown)					
Communications	Grey,	N/A	Black or	Various	250 - 350mm	450 - 600mm	
Communications	white,		light grey				
	green,						
	Black,						
	purple						
Water	Blue or	Blue polymer or blue or	N/A	Blue or	750mm	750mm minimum	
Water	Grey	uncoated Iron / GRP.	13/73	Blue/black	7 3011111	7 3011111 111111111111111	
	Giey	Blue polymer with		Dide/black			
		brown stripe					
		(removable skin					
		revealing white or black					
		pipe)					
Water pipes for	N/A	Blue polymer with	N/A	Blue or	750mm	750mm minimum	
special purposes		brown stripes (non-		blue/black			
(e.g.		removable skin)					
contaminated		•					
ground)							
- '							
			1	1		ı	

LOCATIONS TO BE AGREED 1 x 100mmØ LV DUCT 📙

2 x 100mmØ SPARE DUCT FOR SIGNAGE

BETWEEN METER LOCATIONS

32MM PROTECTA-LINE MCW —

MWLD METER LOCATION -

1 x 100mmØ ELV DUCT FOR FUTURE

2 x 150mmØ EVC DUCT 3 x 100mmØ ELV DUCT)--

2 x 100mmØ LTG DUCT

1 x 100mmØ LV DUCT

1 x 50mmØ EVC DUCT

1 x 50mmØ ELV DUCT

1 x 50mmØ EVC DUCT

1 x 50mmØ ELV DUCT

2 x BT DUCT (SIZE TBC BY BT)

LOCATIONS TO BE AGREED

2 x 100mmØ ALTERNATE COMMS DUCT

90MM INCOMING MDPE GAS

CAPPED OFF BELOW GROUND AT

BOUNDARY FOR FUTURE METER KIOSK

BARRIER

2 x 100mmØ LV DUCT

CCTV/SIGNAGE

2 x 150mmØ EVC DUCT

4 x 100mmØ ELV DUCT

2 x 100mmØ LTG DUCT

4 x 100MMØ SPARE DUCT FOR

LEGEND OF EXTERNAL LIGHTING SYMBOLS					
SYMBOL	DESCRIPTION				
000	6m EXTERNAL LIGHTING COLUMN				

SYMBOL DESCRIPTION EVC ELECTRIC VEHICLE CHARGER	<u> </u>	LEGEND OF POWER SYMBOLS				
EVC ELECTRIC VEHICLE CHARGER	SYMBOL	DESCRIPTION				
	EVC	ELECTRIC VEHICLE CHARGER				

LEGEND OF EXTERNAL DUCT SYMBOLS

DESCRIPTION

ALTERNATIVE COMMS/DATA DUCT

EXTERNAL SPRINKLER PIPEWORK

EXTERNAL RAINWATER PIPEWORK

EXTERNAL BOOSTED COLD WATER

DRAW PIT (900mm x 900mm)

DRAW PIT (1000mm x 1000mm)

■JUF6 BT PIT - EXACT DETAILS TBC BY BT

LEGEND OF SMALL POWER & DATA SYMBOLS

NEW TPN DISTRIBUTION BOARD

ALL HV / LV CABLE DUCTS ARE TO HAVE SLOW RADIUS BENDS.

4. ALL DUCTS AND BELOW GROUND SERVICES ARE TO BE INSTALL IN

5. ALL DRAW PITS ARE TO BE HEAVY DUTY TYPE TO WITHSTAND THE

PRE-FORMED DEMOUNTABLE POLE CHAMBER SYSTEMS WHICH

COMBINE COLUMN CHAMBER AND CABLE CHAMBER FOR EASE OF

8. ALL HV / LV CABLING ARE PROVIDED WITH THE NECESSARY WARNING

9. ALL BELOW GROUND DUCTING IS TWIN WALL TYPE COMPLETE WITH

ASSOCIATED VEHICLE TRAFFIC, DEPENDING UPON AREA.

6. ALL EXTERNAL LIGHTING COLUMNS TO BE PROVIDED WITH

7. ALL BT DUCTING AND CHAMBERS TO BE INSTALLED TO BT

ACCORDANCE WITH THE NJUG STANDARD DEPTHS.

3. ALL DUCTS ARE TO BE LEFT WITH DRAW CORDS FOR EASE OF FUTURE

DO NOT SCALE FROM THE DRAWING.

WIRING AND MAINTENANCE.

SPECIFICATION AND STANDARDS.

CABLE PULLING.

MARKER TAPES.

SMOOTH INTERIOR.

<u>DESCRIPTION</u>

EXTERNAL GAS PIPEWORK

SYMBOL

____ D ____

NOTES

— DUCT — SPARE DUCT

__ LV LIGHTING DUCT

LV DUCT

ELV DUCT


BT DUCT (BT SPECIFICATION)

EVC DUCT

EXTERNAL MAINS COLD WATER

—— DUCT —— EXTERNAL DUCT (100Ø & 150Ø)

■ DP1 DRAW PIT (600mm x 600mm)

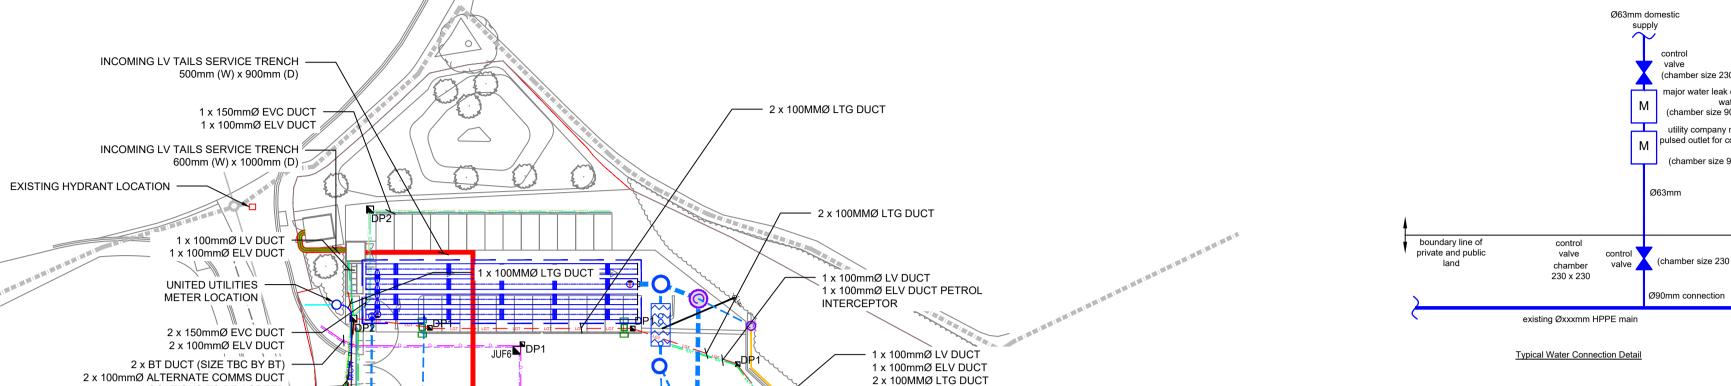

1 x 100MMØ LTG DUCT

1 x 100mmØ LV DUCT

2 x 100MMØ LTG DUCT

1 x 100mmØ ELV DUCT

2 x 100MMØ LTG DUCT


1 x 100mmØ LV DUCT


2 x 100MMØ SPARE DUCT FOR CCTV


2 x 100MMØ SPARE DUCT FOR CCTV


2 x 100MMØ SPARE DUCT FOR CCTV


1 x 100mmø LV DUCT 1 x 100mmø ELV DUCT

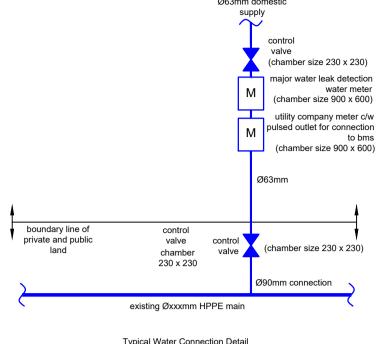


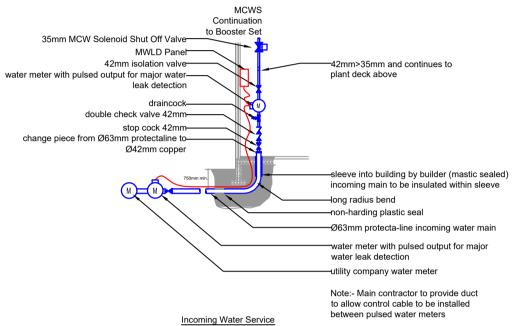

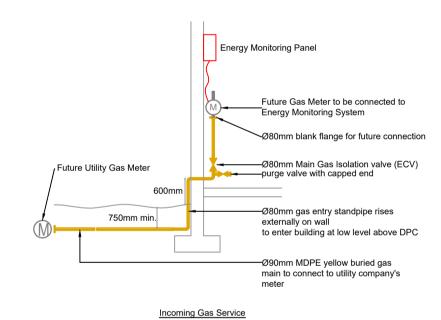


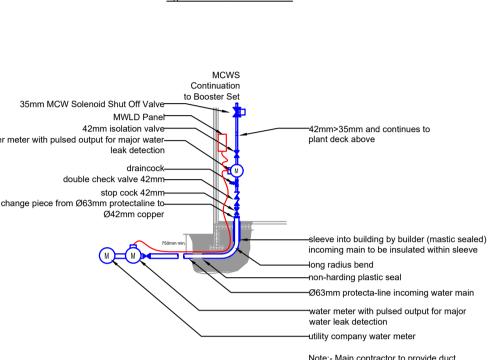

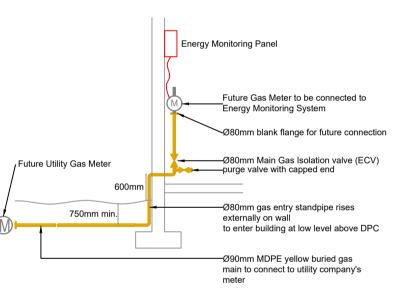


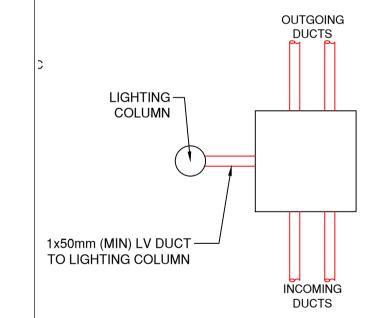

TYPICAL LIGHTING COLUMN AND DRAW PIT PLAN 'DETAIL 1'

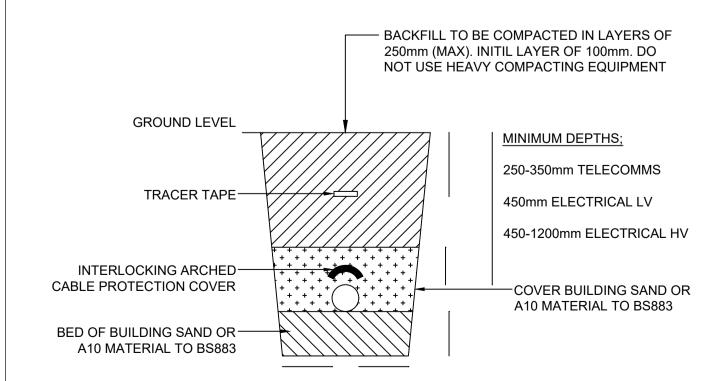

TYPICAL TRENCH DETAIL FOR FOOTPATH / VERGE ELECTRIC DUCT / CABLE

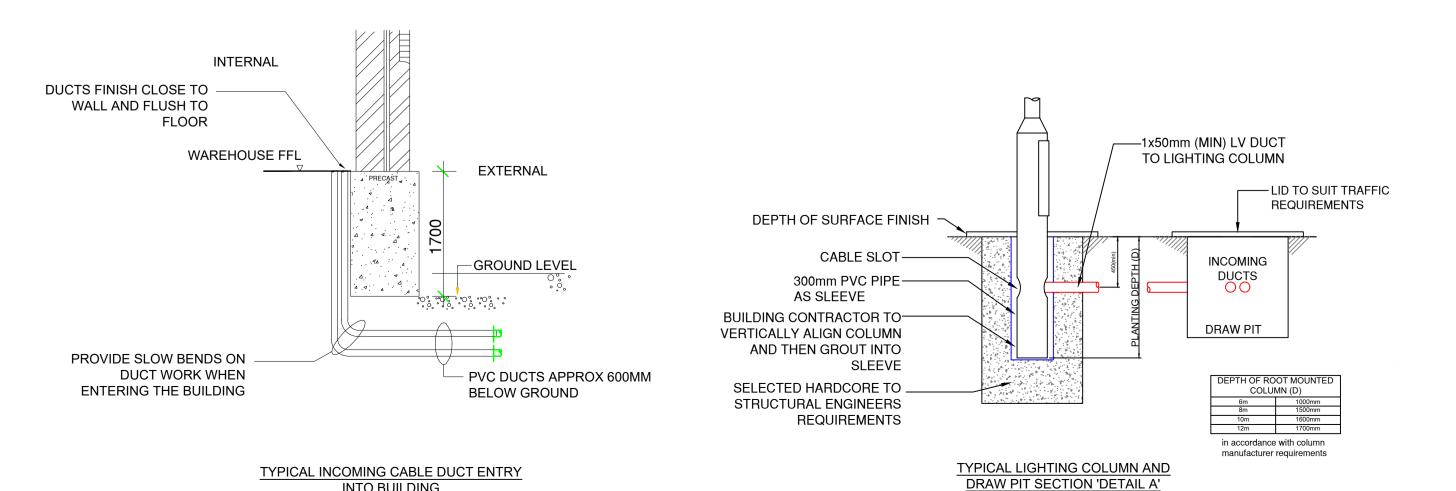

2 x 100mmØ LV DUCT

CCTV/SIGNAGE

100MM DUCT BY OTHERS FOR POWER/CONTROL WIRING

90MM INCOMING MDPE GAS CONVERTS TO 80MM STEEL

100MM DUCT BY OTHERS FOR ENERGY MONITORING CABLE

WITHIN LOCKABLE BOX 63MM INCOMING BLACK/GREEN MDPE RWH INFILL

63MM INCOMING PROTECTA-LINE MCW

2 x 100MMØ SPARE DUCT FOR CCTV

INTO BUILDING

2 x 150mmØ EVC DUCT

4 x 100mmØ ELV DUCT

2 x 100MMØ LTG DUCT

2 x 150mmØ LV DUCT

2 x 150MMØ SPARE DUCT

100MM DUCT BY OTHERS FOR MAJOR WATER LEAK DETECTION CABLE

4 x 100MMØ SPARE DUCT FOR

WALL MOUNTED BIB TAP SERVED BY BOOSTED RAINWATER SUPPLY,







Project UNIT 3 WINGATES, **BOLTON**

> **UNIT 3 COMBINED M&E EXTERNAL SERVICES LAYOUT**

	Scale	16.10.2023				
	Drawn	LH	Checked	TW	Approved	XX
	Drg. No.	Rev.				
	P2	AF				
00			GHT AND MAY NOT ISSION FROM EBM I		EITHER IN PART OR	FULL